MEMORANDUM



TO: MEMBERS OF THE PLANNING COMMISSION

THRU: BARBARA MCBETH, *AICP*, CITY PLANNER

FROM: SRI RAVALI KOMARAGIRI, PLANNER

SUBJECT: JSP 18-74 SLI MEDICAL OFFICE BUILDING

DATE: OCTOBER 25, 2019

The purpose of this memo is to provide some background information on the applicant's request for approval of a revised site layout. The Planning Commission approved the Preliminary Site Plan and the storm water management plan at their June 12, 2019 meeting Action summary is listed at the end of this letter.

The approval motion required the applicant to submit a truck circulation diagram as part of the final site plan. In order address this comment, the applicant noted that the removal of proposed landscape islands is warranted to allow reasonable space for truck maneuvering. The current revised plan no longer proposes end islands north of the building enclosed on the red box in the image below. The parking spaces are relocated to west as indicated in the blue box. The plan as currently proposed meets the Ordinance requirements and previously approved waivers, but it is slightly different from the site layout from the Planning Commission approval.

PREVIOUS APPROVED LAYOUT



CURRENT REVISED LAYOUT



The revisions resulted in loss of green space in two locations:

- a. The loss of two end islands resulted in reduction of green space by approximately 600 square feet of landscaped area and the removal of four proposed trees.
- b. The curb south of the loading area is now pulled back to enable safe truck turning movements, but it resulted in the loss of green space.

However, the applicant has closely worked with our landscape architect and addressed the entire comments listed in the review letters. All reviews are recommending approval at this time to move forward to electronic stamping sets.

The Planning Commission is asked to approve the revised site plan, supported by staff to allow the applicant to move forward with the site plan approval process. The following motion is suggested for approval

Approval - Revised Preliminary Site Plan

In the matter of request of SLI Medical for JSP 18-74 SLI Medical Office Building, motion to approve the Revised Preliminary Site Plan based on and subject to the following:

1. The findings of compliance with Ordinance standards in the staff and consultant review letters and the remaining items listed in those letters being addressed on the electronic stamping set submittal; and

(This motion is made because the plan is otherwise in compliance with Article 3, Article 4, and Article 5 of the Zoning Ordinance and all other applicable provisions of the Ordinance.)

JUNE 12, 2019 PLANNING COMMISSION MEETING ACTION SUMMARY

The Planning Commission approved the Preliminary Site Plan and the storm water management plan at their June 12, 2019 meeting based on the following motion:

In the matter of request of SLI Medical for JSP 18-74 SLI Medical Office Building, motion to approve the Preliminary Site Plan based on and subject to the following:

- 1. The applicant shall revise the layout to provide a minimum of 75 parking spaces including the minimum required barrier free spaces at the time of final site plan;
- 2. The applicant shall provide a truck circulation diagram as noted in the Traffic review letter at the time of final site plan;
- 3. Traffic waiver to allow Parking study in lieu of performing a Traffic Impact study because the change in number of trips from existing use is not significant, which is hereby granted;
- 4. The applicant shall provide a revised landscape plan, subject to approval of the City's Landscape Architect, that complies with the following landscape waivers, at the time of final site plan approval:
 - c. Landscape waiver from Sec. 5.5.3.B.ii for lack of street trees along Grand River Avenue frontage due to conflicts with existing utilities in right-of-way, which is hereby granted;
 - d. Landscape waiver from Sec. 5.5.3.C.iv for not meeting the minimum required parking lot perimeter trees due to a lack of room between the parking and the west property line, provided that the applicant work with the City's landscape architect to maximize number of trees along other areas of the parking lot, which is hereby granted;
 - e. Landscape waiver from Sec. 5.5.3.B.ii for reduction in required greenbelt width along Grand River Avenue due to existing conditions which were previously approved, which is hereby granted;
 - f. Landscape waiver from Sec. 5.5.3.B.ii for lack of berm along Grand River Avenue, due to existing grading which is not changing, which is hereby granted;
 - g. Landscape waiver from Sec 5.5.3.D. for proposing less than 75% of the building foundation with landscaping, and locating some foundation area away from the building along the existing berm facing Grand River Avenue, which is hereby granted;
- 5. Zoning Board of Appeals variance from Section 5.2.12. for reduction of minimum required parking for the proposed use (122 spaces required, 75 spaces proposed);
- 6. The findings of compliance with Ordinance standards in the staff and consultant review letters and the remaining items listed in those letters being addressed on the Final Site Plan.

This motion is made because the plan is otherwise in compliance with Article 3, Article 4, and Article 5 of the Zoning Ordinance and all other applicable provisions of the Ordinance.

1. In the matter of request of SLI Medical for JSP 18-74 SLI Medical Office Building, motion to approve the Stormwater Management Plan based on and subject to the findings of compliance with Ordinance standards in the staff and consultant review letters, and the conditions and items listed in those letters being addressed on the Final Site Plan. This motion is made because it otherwise in compliance with Chapter 11 of the Code of Ordinances and all other applicable provisions of the Ordinance.

MAPS Location

JSP 18-74 SLI MEDICAL OFFICE BUILDING

Location





LEGEND





City of Novi

Dept. of Community Development City Hall / Civic Center 45175 W Ten Mile Rd Novi, MI 48375 cityofnovi.org

Map Author: Sri Komaragiri Date: 06/07/19 JSP 18-74 SLI Medical Office Building Version #: 1

Feet 0 20 40 80 120




1 inch = 98 feet

MAP INTERPRETATION NOTICE

Map information depicted is not intended to replace or substitute for any official or primary source. This map was intended to meet National Map Accuracy Standards and use the most recent, accurate sources available to the people of the City of Novi. Boundary measurements and area calculations are approximate and should not be construed as survey measurements performed by a licensed Michigan Surveyor as defined in Michigan Public Act 132 of 1970 as amended. Please contact the City GIS Manager to confirm source and accuracy information related to this map.

PREVIOUSLY APPROVED SITE LAYOUT

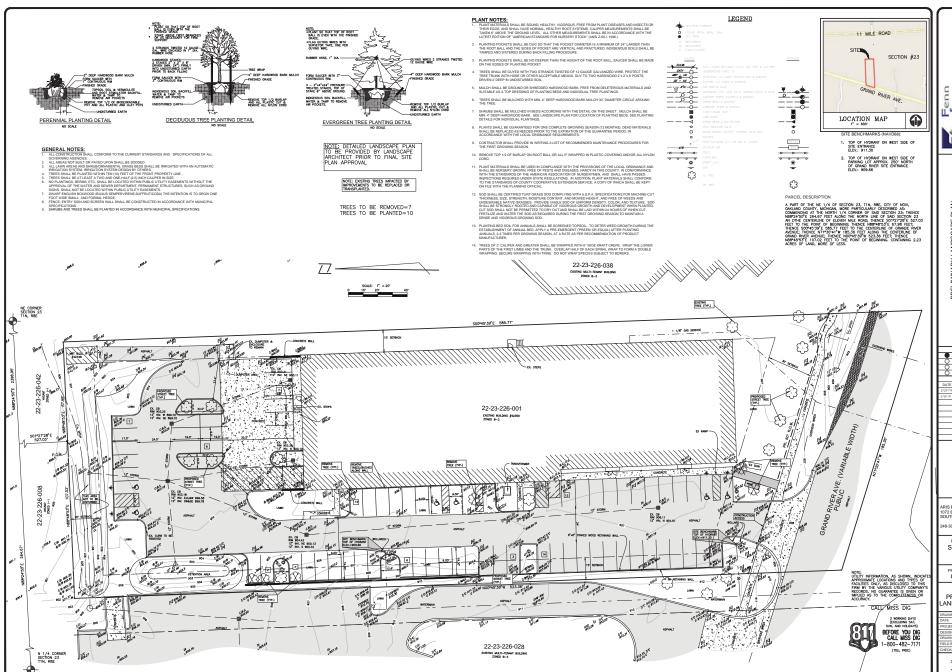

Fenn Associates, Inc. Associates Inc. adSurveying and Chul Engineering and Surveying and Chul Engineering States of the States o

PRELIMINARY LANDSCAPE PLAN
SLI MEDICAL
ART OF THE NE 14 OF SECTION 23, THI, RBE,
CITY OF NOVI, OAKLAND COUNTY, MICHIGAN

SEAL

BERRIS EQUESTRIAN DR TH LYON, MI 4801 808-2846

PROJECT NAME SLI MEDICAL

PROJECT NUMBER C18-033.02

SHEET NAME
PRELIMINARY
LANDSCAPE PLAN

ANDSCAPE PLAN

AWING SCALE: 1°= 20′

TE: 09/25/18

DJECT MANAGER: JSR, P.E.

SIGNED BY: JJS, P.E.

JUSP P.E.

JUSP P.E.

WN BY: JUSP P.E.

WN BY: JUSP P.E.


D BY: BH, VA

CKED BY: TWDUSR,

SHEET NI IMBEP

1 OF 1

REVISED SITE LAYOUT

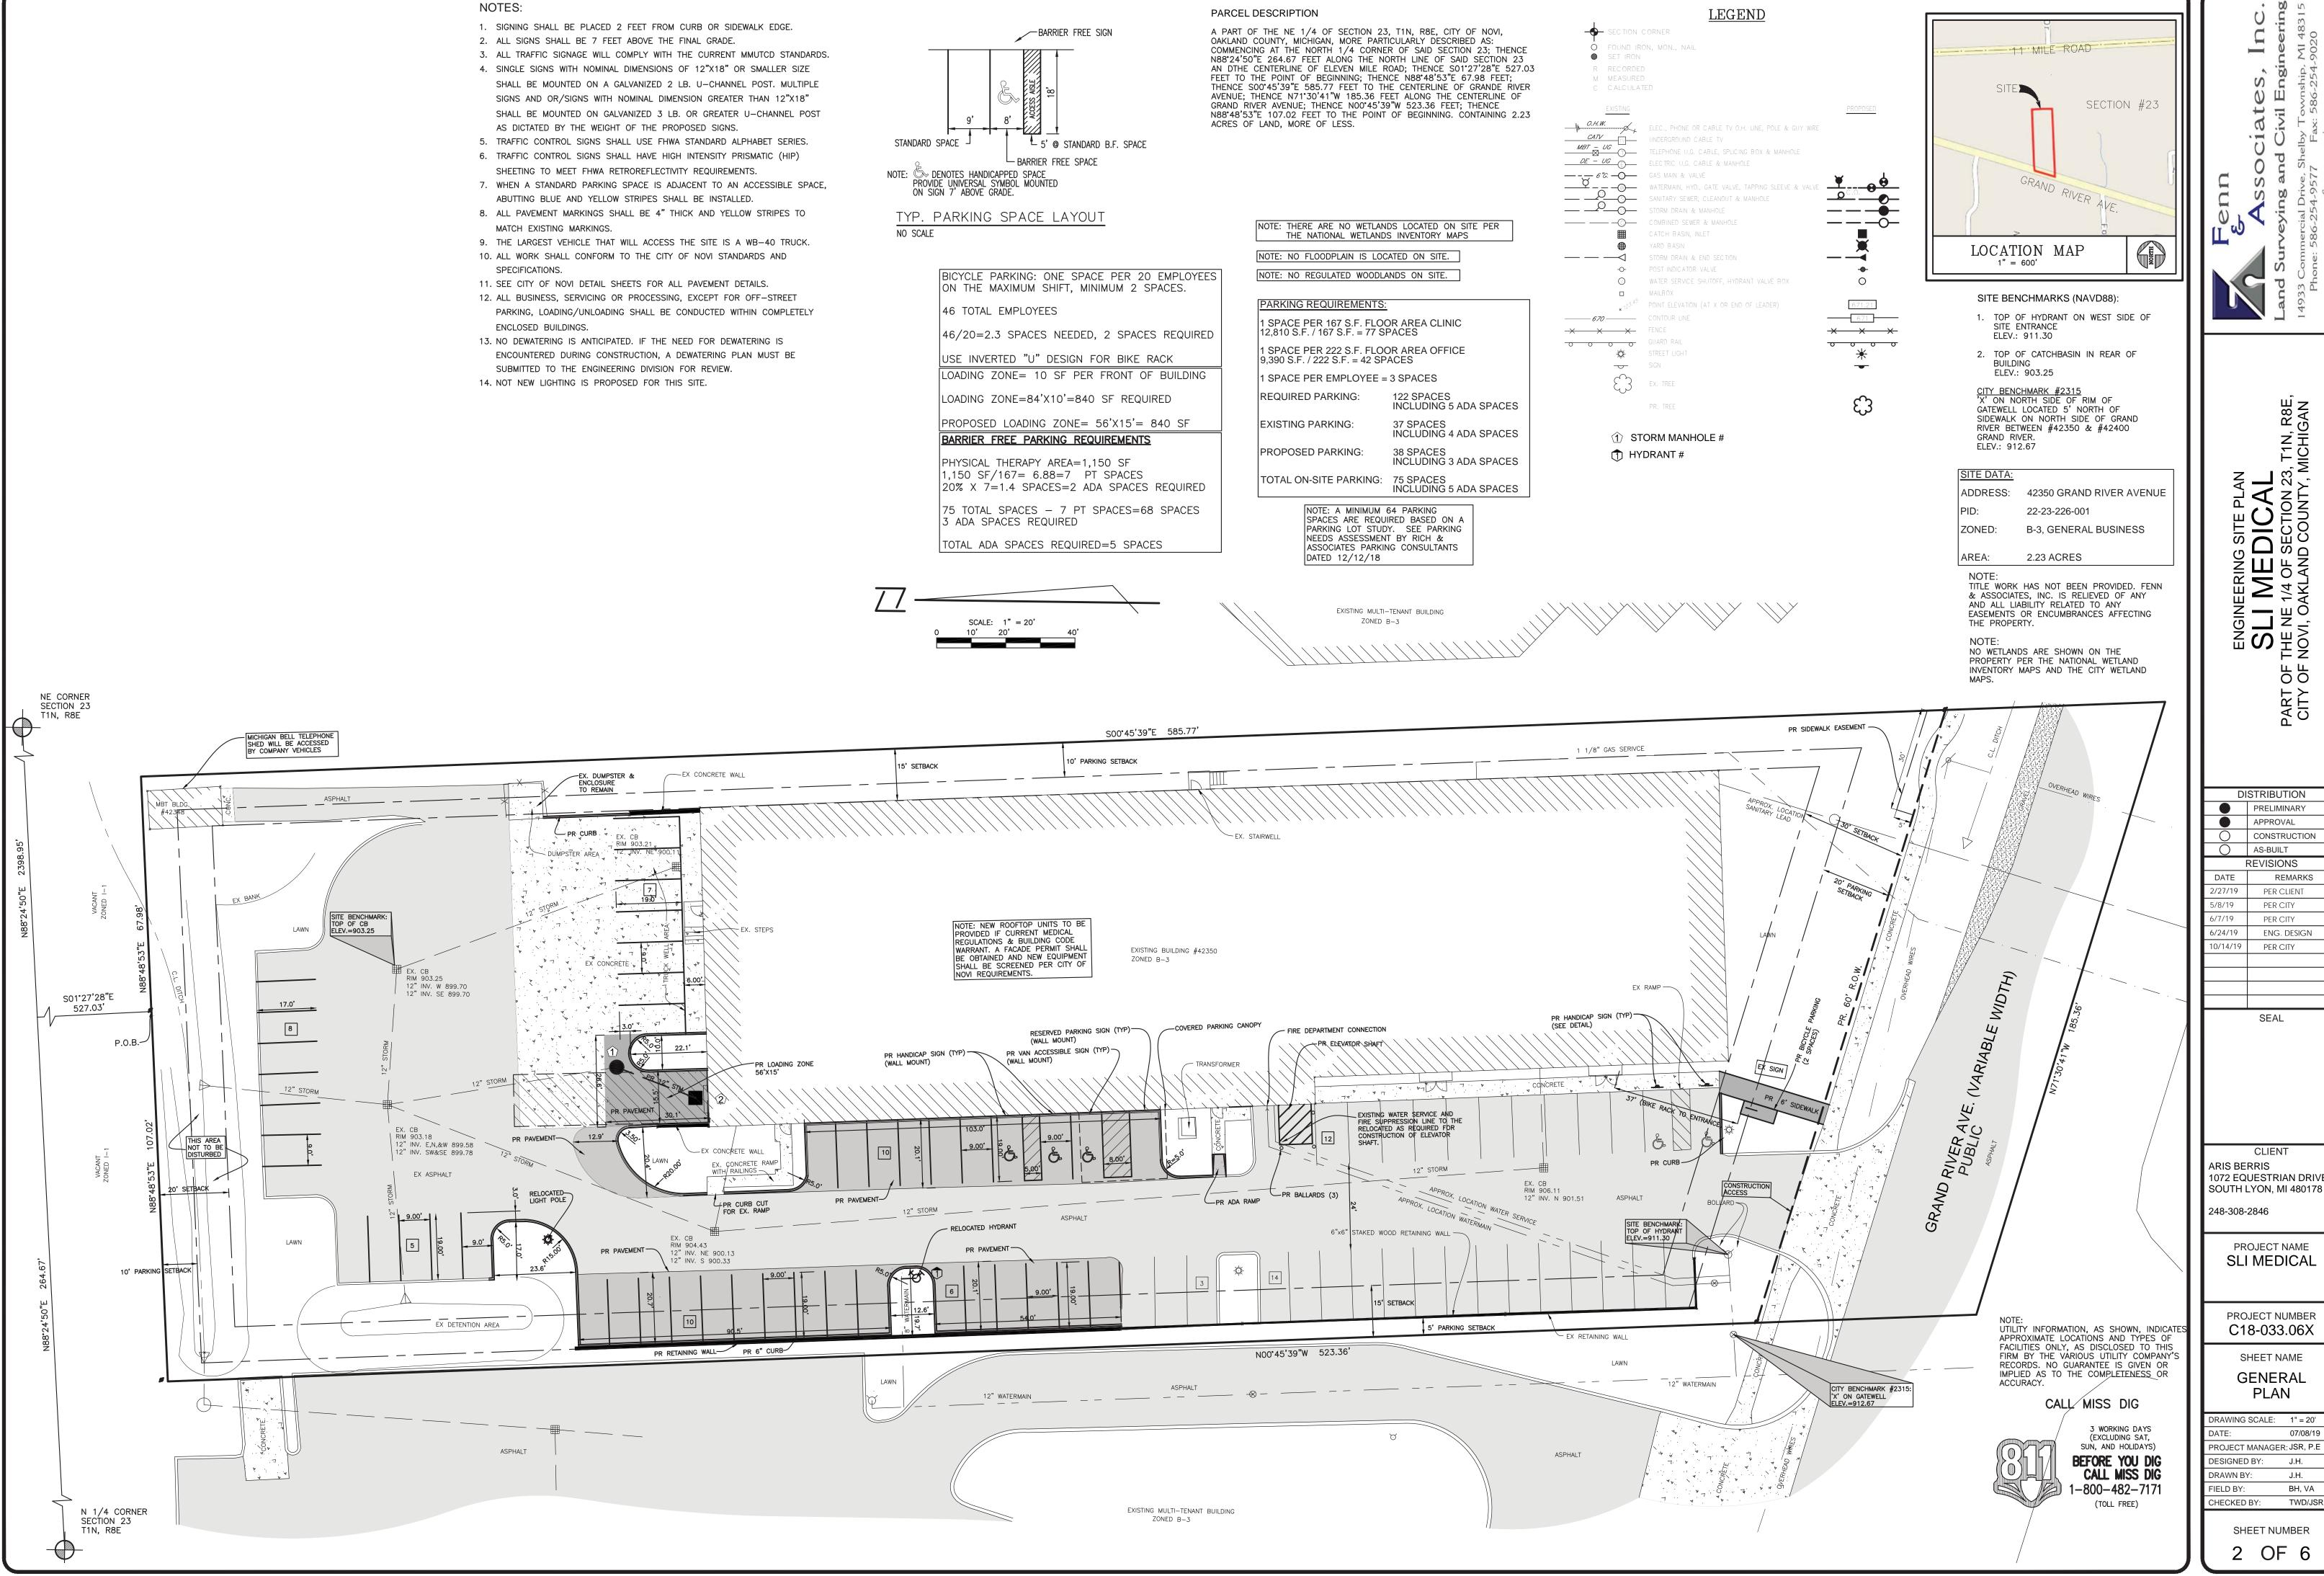

ĭ Ш ⊬ 型**の** 出る

T1N, R8E, IICHIGAN

 $\overline{}$

DISTRIBUTION PRELIMINARY APPROVAL CONSTRUCTION

AS-BUILT REVISIONS REMARKS PER CLIENT PER CITY

PER CITY ENG. DESIGN PER CITY

SEAL

CLIENT **ARIS BERRIS** 1072 EQUESTRIAN DRIVE

PROJECT NAME


SLI MEDICAL

PROJECT NUMBER C18-033.06X

SHEET NAME **GENERAL** PLAN

DRAWING SCALE: 1" = 20' PROJECT MANAGER: JSR, P.E DESIGNED BY: DRAWN BY: FIELD BY: BH, VA CHECKED BY: TWD/JSR, F

> SHEET NUMBER 2 OF 6

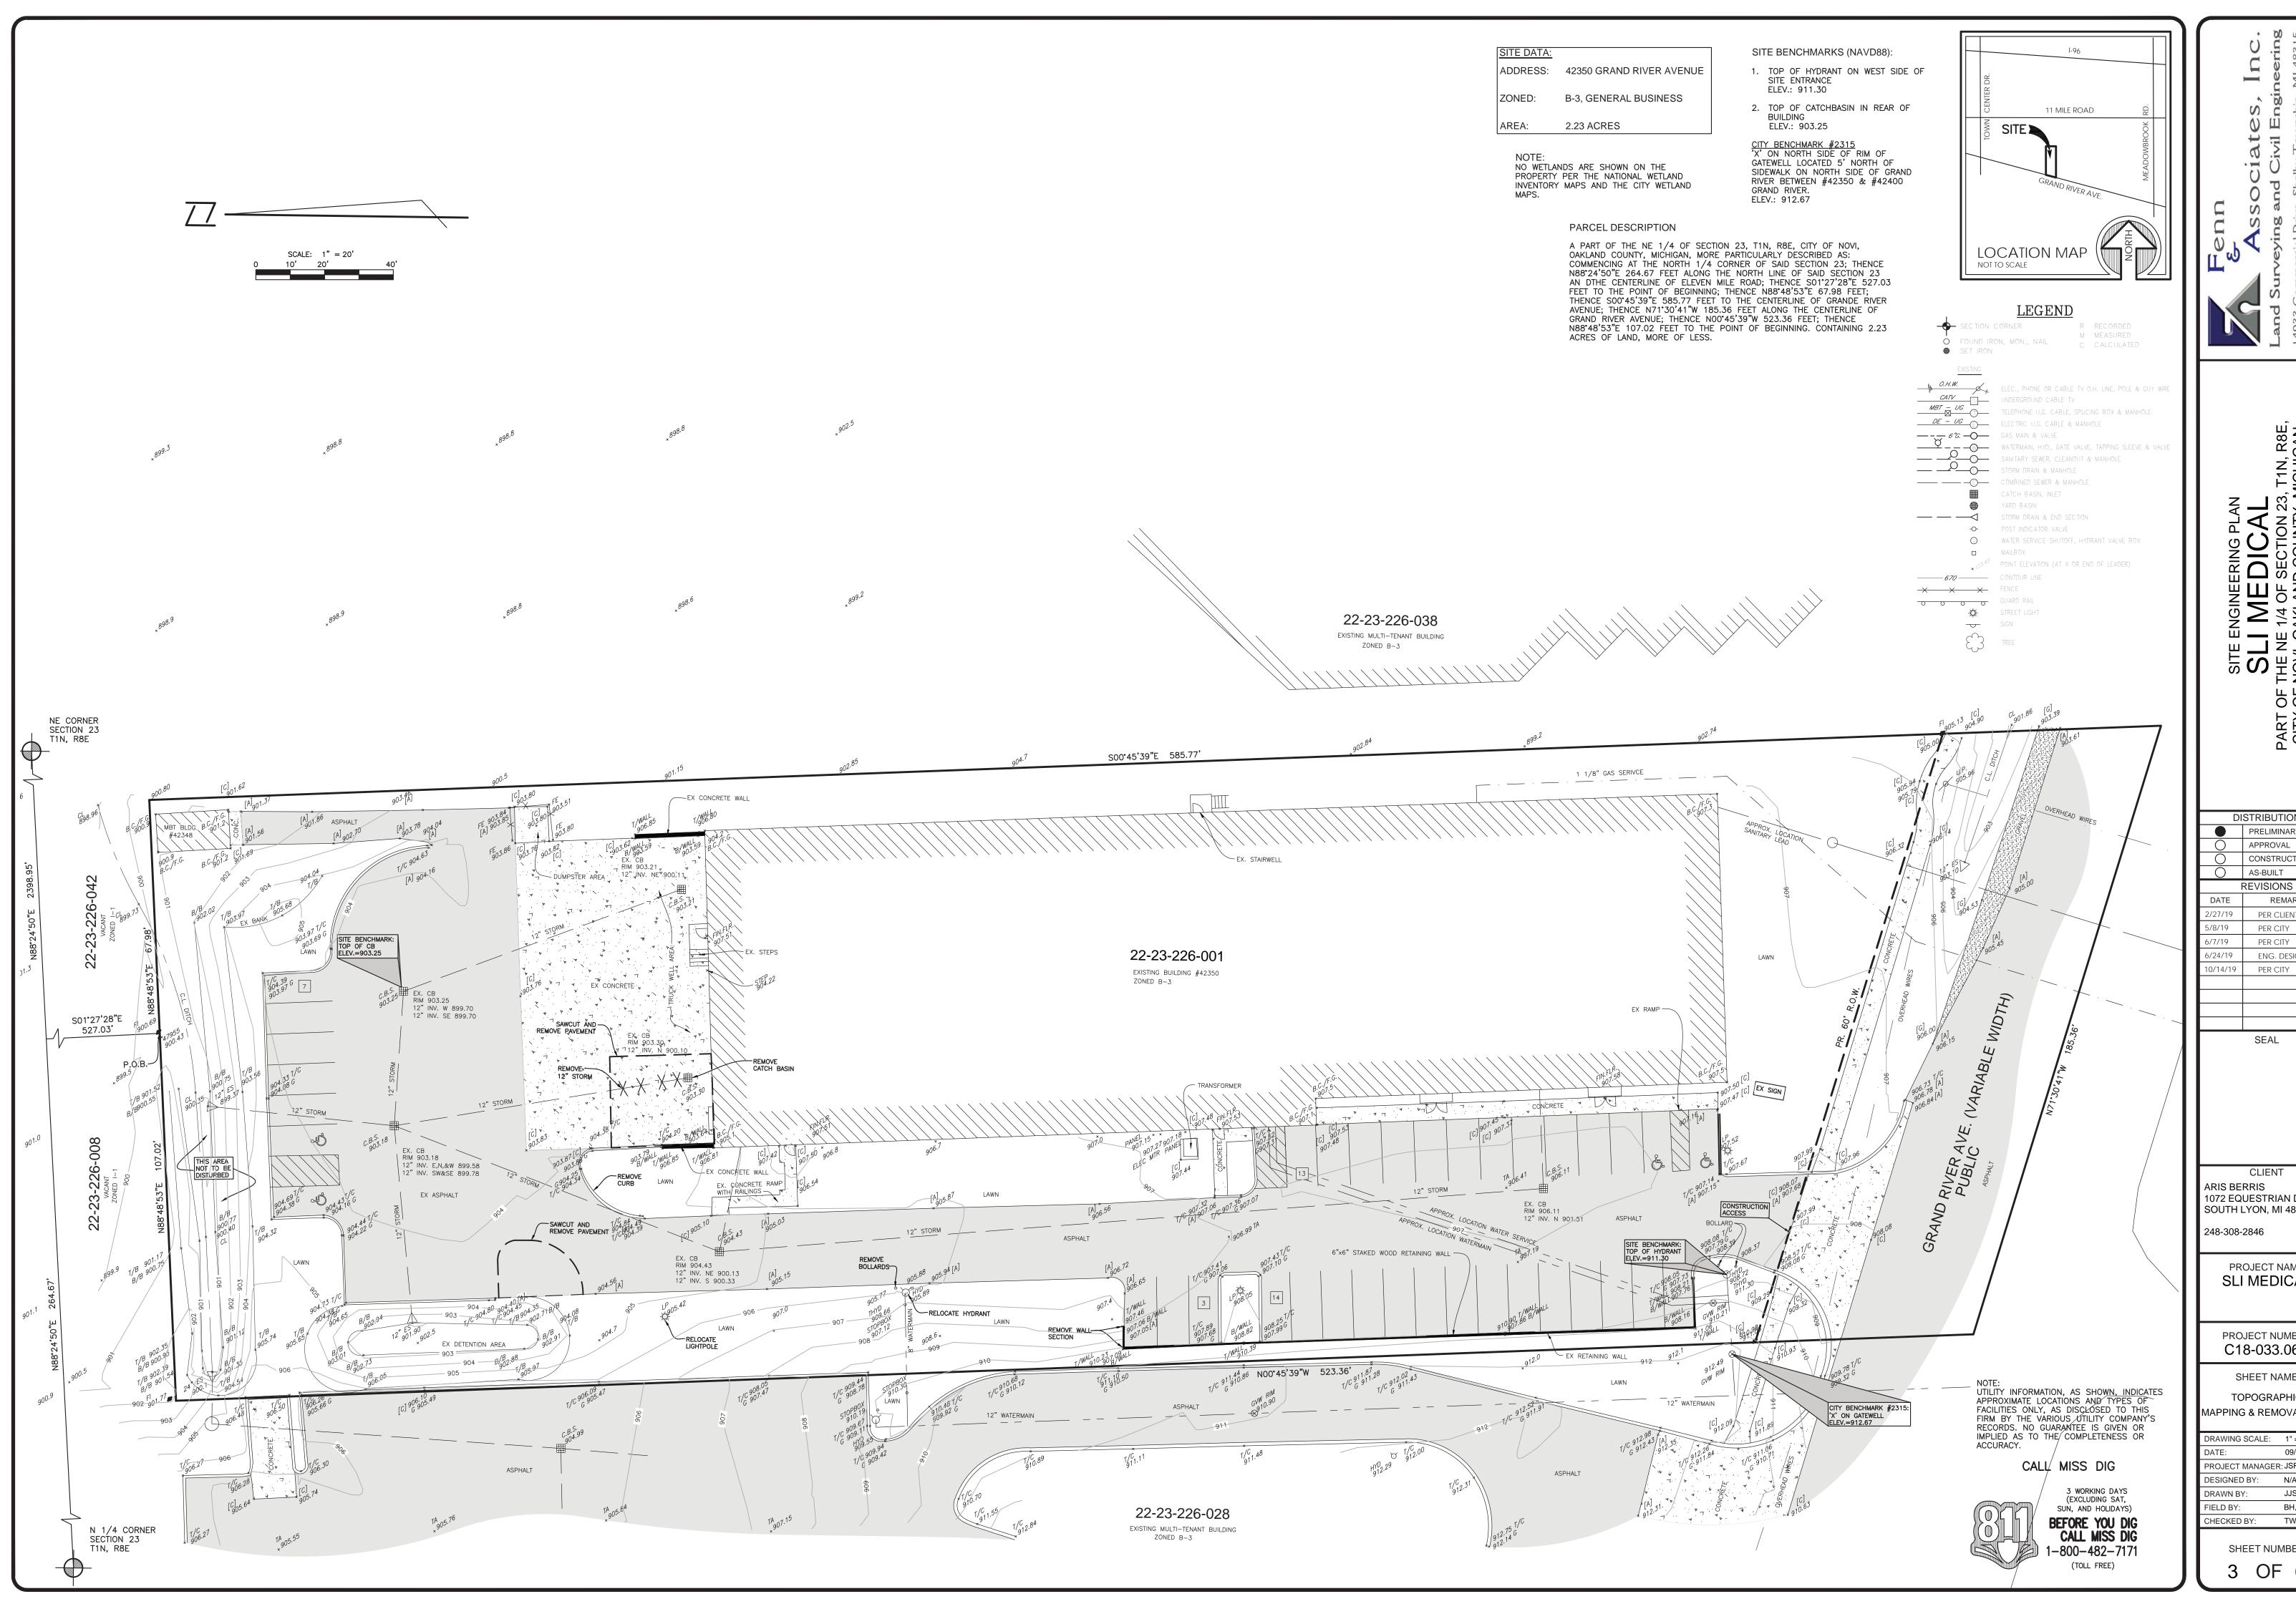

SITE I

DISTRIBUTION PRELIMINARY APPROVAL CONSTRUCTION

REVISIONS REMARKS PER CLIENT PER CITY PER CITY ENG. DESIGN

SEAL

CLIENT 1072 EQUESTRIAN DRIVE SOUTH LYON, MI 480178

> PROJECT NAME SLI MEDICAL

PROJECT NUMBER


C18-033.06X

SHEET NAME TOPOGRAPHIC MAPPING & REMOVAL PLAI

DRAWING SCALE: 1" = 20' PROJECT MANAGER: JSR, P.E JJS, P.E. BH, VA

TWD/JSR, P

SHEET NUMBER 3 OF 6

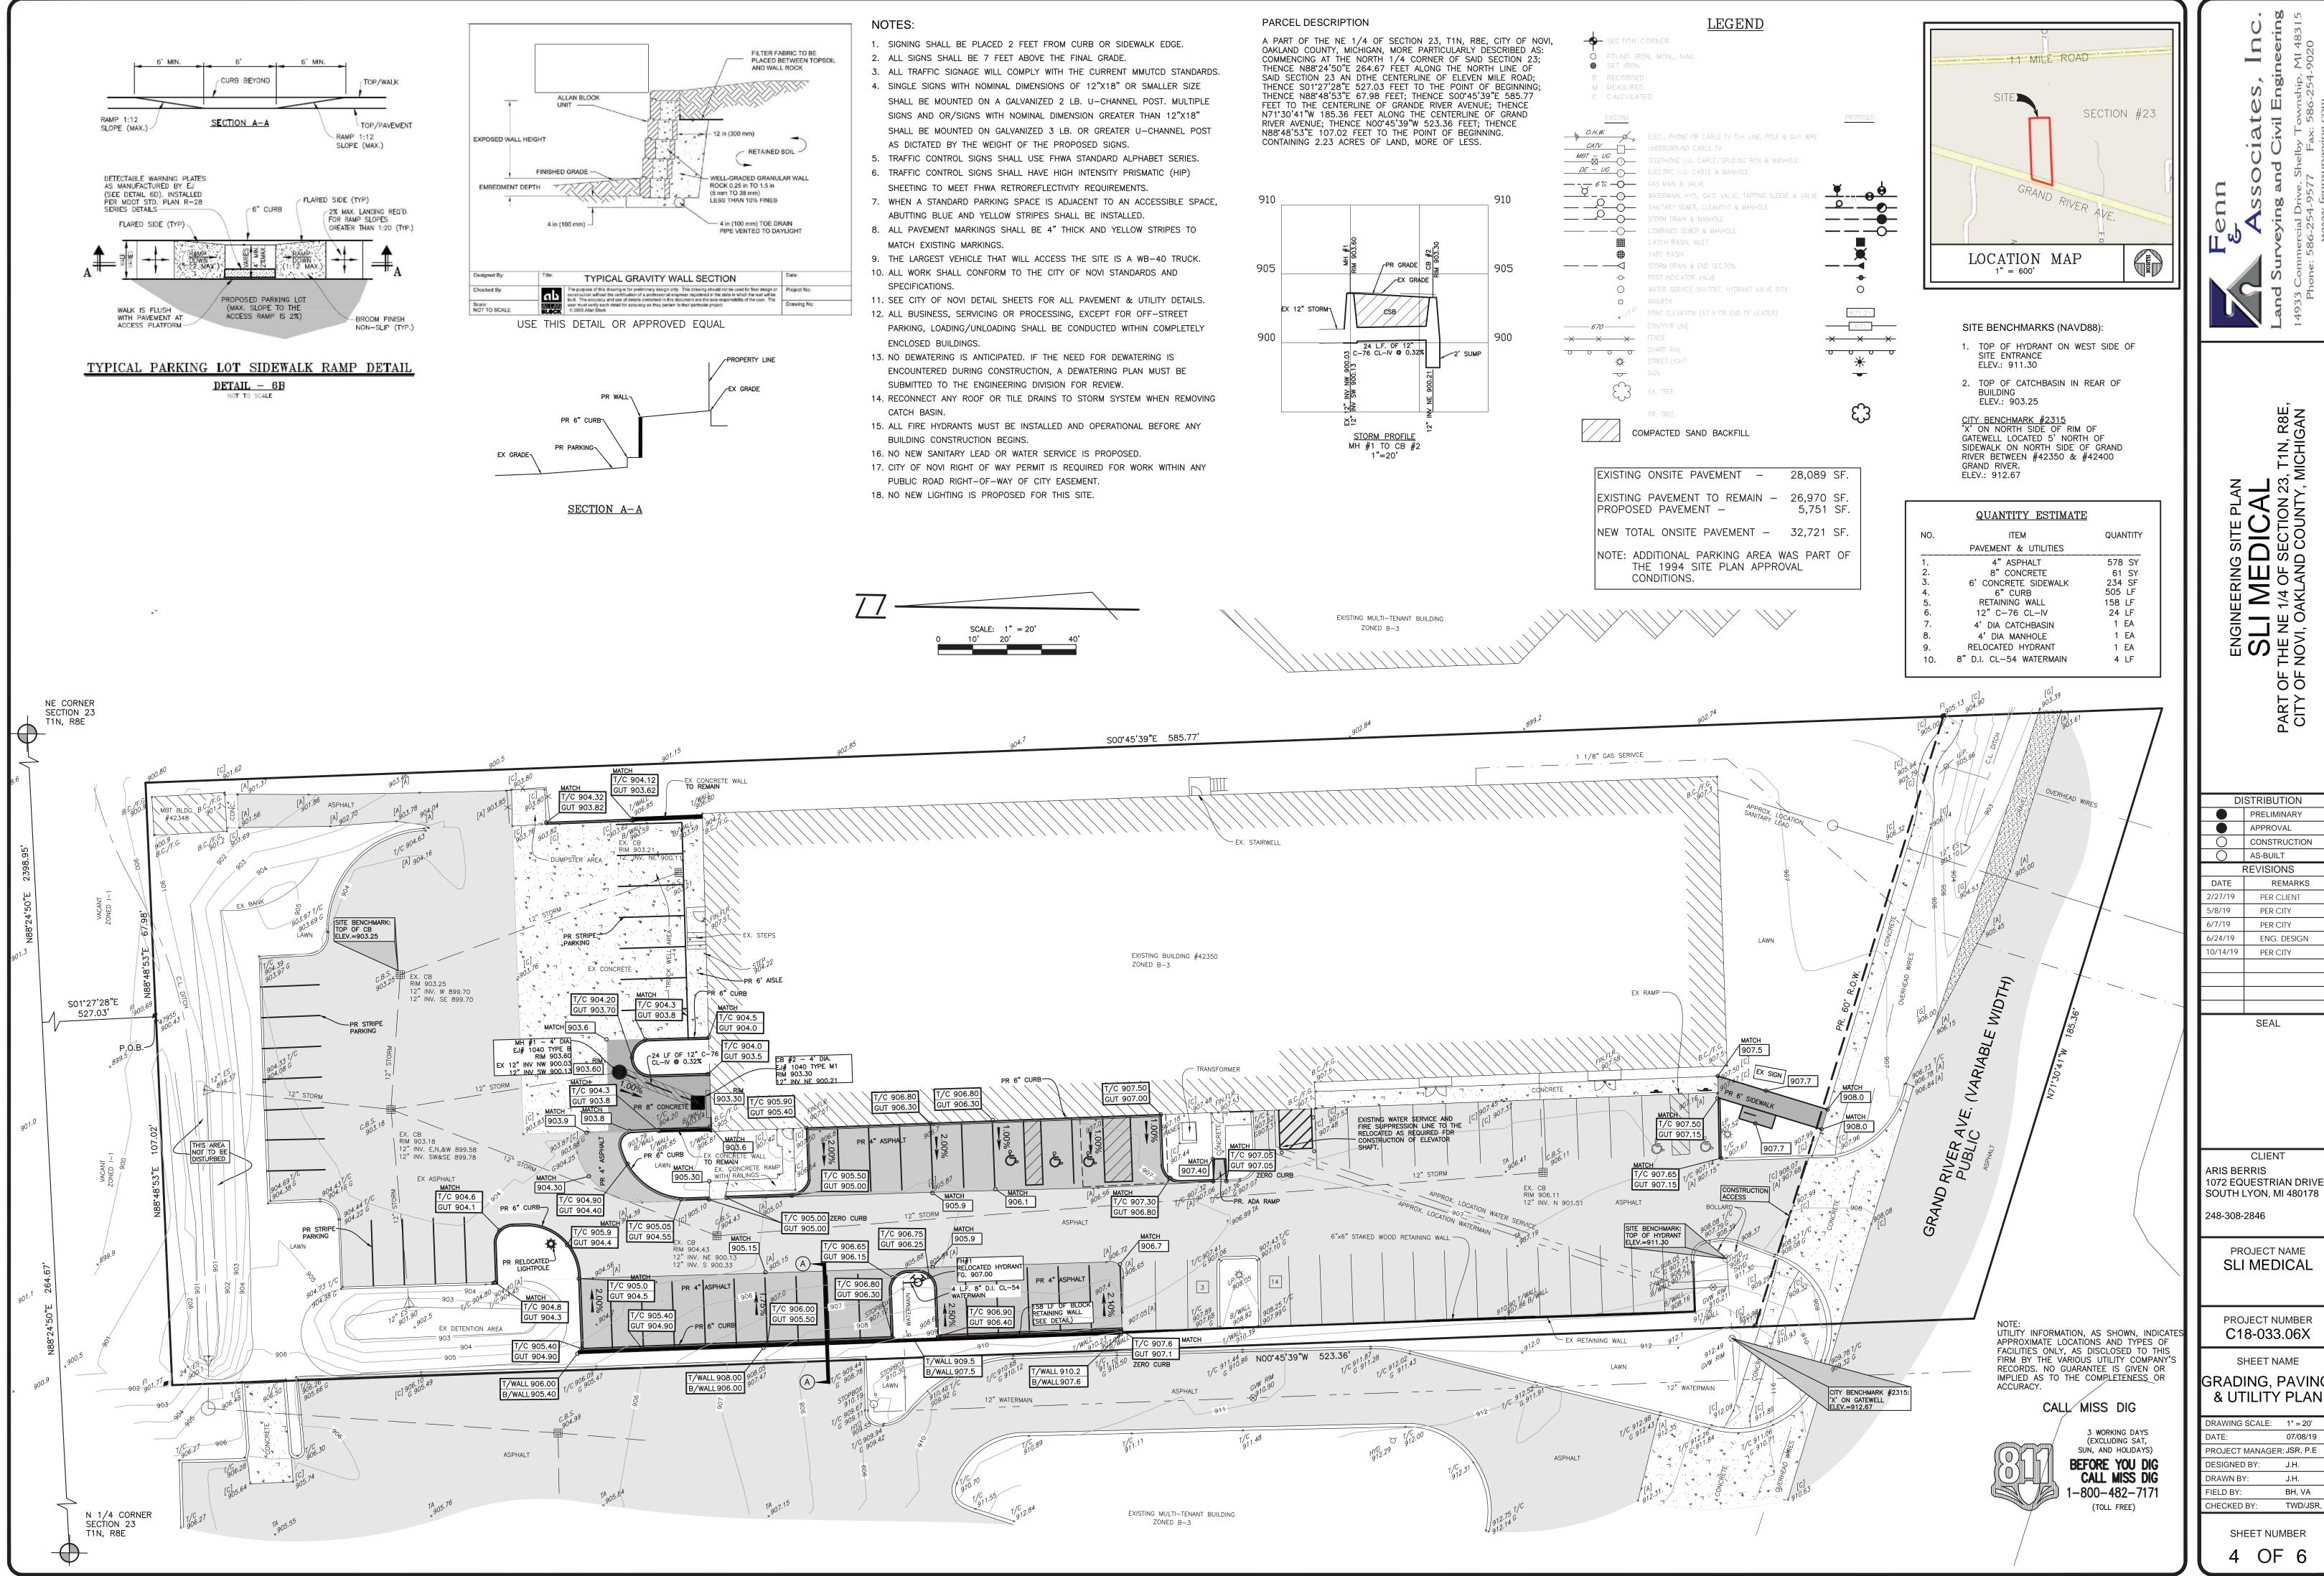

DISTRIBUTION

PRELIMINARY APPROVAL CONSTRUCTION AS-BUILT REVISIONS REMARKS

PER CITY

T1N, R8E, IICHIGAN

PER CITY ENG. DESIGN PER CITY

SEAL

CLIENT

SLI MEDICAL

PROJECT NUMBER C18-033.06X


SHEET NAME


GRADING, PAVING & UTILITY PLAN DRAWING SCALE: 1" = 20'

PROJECT MANAGER: JSR, P.E DESIGNED BY: BH, VA


TWD/JSR, F

SHEET NUMBER OF 6

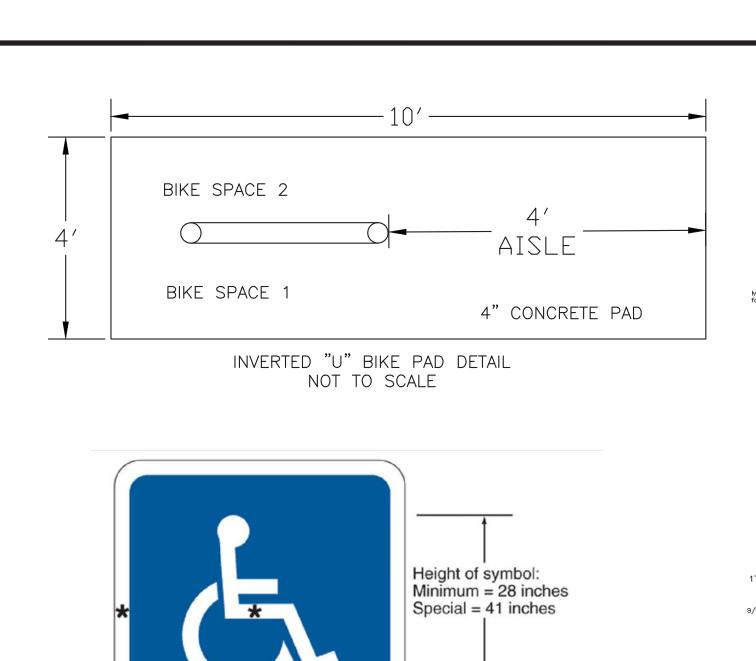

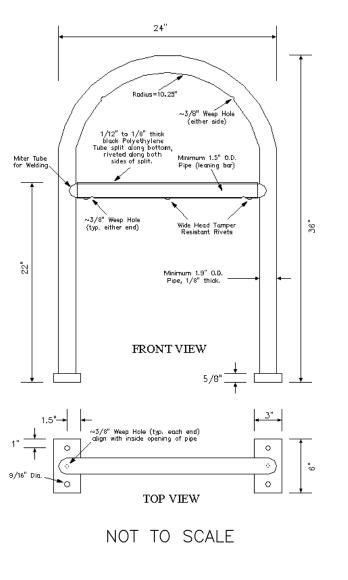

"INVERTED U" BIKE RACK

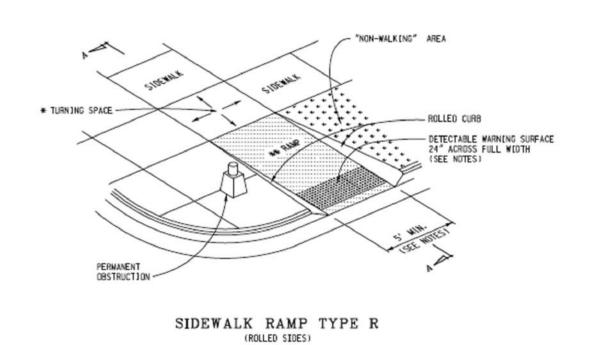



HANDICAP SIGN

(R7-8)




(R7-8b)



RESERVED SIGN

PARCEL DESCRIPTION

A PART OF THE NE 1/4 OF SECTION 23, T1N, R8E, CITY OF NOVI, OAKLAND COUNTY, MICHIGAN, MORE PARTICULARLY DESCRIBED AS: COMMENCING AT THE NORTH 1/4 CORNER OF SAID SECTION 23; THENCE N88°24'50"E 264.67 FEET ALONG THE NORTH LINE OF SAID SECTION 23 AN DTHE CENTERLINE OF ELEVEN MILE ROAD; THENCE S01°27'28"E 527.03 FEET TO THE POINT OF BEGINNING; THENCE N88'48'53"E 67.98 FEET; THENCE S00'45'39"E 585.77 FEET TO THE CENTERLINE OF GRANDE RIVER AVENUE; THENCE N71°30'41"W 185.36 FEET ALONG THE CENTERLINE OF GRAND RIVER AVENUE; THENCE NO0°45'39"W 523.36 FEET; THENCE N88'48'53"E 107.02 FEET TO THE POINT OF BEGINNING. CONTAINING 2.23 ACRES OF LAND, MORE OF LESS.

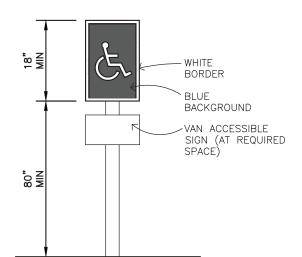




SIGN QUANTITIES TABLE					
TYPE	QUANTITY	DIMENSIONS			
HANDICAP SIGN	4	12"X18"			
VAN ACCESSIBLE	1	12"X18"			
RESERVED SIGN	1	12"X18"			

NOTES:

- 1. SIGNING SHALL BE PLACED 2 FEET FROM CURB OR SIDEWALK EDGE.
- 2. ALL SIGNS SHALL BE 7 FEET ABOVE THE FINAL GRADE.
- 3. ALL TRAFFIC SIGNAGE WILL COMPLY WITH THE CURRENT MMUTCD STANDARDS.
- 4. SINGLE SIGNS WITH NOMINAL DIMENSIONS OF 12"X18" OR SMALLER SIZE SHALL BE MOUNTED ON A GALVANIZED 2 LB. U-CHANNEL POST. MULTIPLE SIGNS AND OR/SIGNS WITH NOMINAL DIMENSION GREATER THAN 12"X18" SHALL BE MOUNTED ON GALVANIZED 3 LB. OR GREATER U-CHANNEL POST AS DICTATED BY THE WEIGHT OF THE PROPOSED SIGNS.
- 5. TRAFFIC CONTROL SIGNS SHALL USE FHWA STANDARD ALPHABET SERIES.
- 6. TRAFFIC CONTROL SIGNS SHALL HAVE HIGH INTENSITY PRISMATIC (HIP) SHEETING TO MEET FHWA RETROREFLECTIVITY REQUIREMENTS.
- 7. WHEN A STANDARD PARKING SPACE IS ADJACENT TO AN ACCESSIBLE SPACE, ABUTTING BLUE AND YELLOW STRIPES SHALL BE INSTALLED.
- 8. ALL PAVEMENT MARKINGS SHALL BE 4" THICK AND YELLOW STRIPES TO MATCH EXISTING MARKINGS.
- 9. THE LARGEST VEHICLE THAT WILL ACCESS THE SITE IS A WB-40 TRUCK.
- 10. ALL WORK SHALL CONFORM TO THE CITY OF NOVI STANDARDS AND

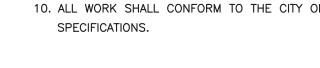



RIVER AVE.	
LOCATION MAP	NORTH
<u>LEGEND</u>	
DN., NAIL	

 $\overline{}$

T1N, R8E, IICHIGAN

DISTRIBUTION

APPROVAL CONSTRUCTION

REVISIONS

PER CITY PER CITY

SEAL

CLIENT

1072 EQUESTRIAN DRIVE SOUTH LYON, MI 480178

> PROJECT NAME SLI MEDICAL

PROJECT NUMBER

C18-033.06X

SHEET NAME

TRUCK TURNING PLAN

ARIS BERRIS

248-308-2846

ENG. DESIGN

REMARKS PER CLIENT

PRELIMINARY

DATE

5/8/19

6/24/19

10/14/19

SET IRON	North, Will	
R RECORDED		
M MEASURED		
C CALCULAT	ED	
EXISTING		PROPOSED
CATV MBT = UG	ELEC., PHONE OR CABLE TV O.H. LINE, POLE & GUY WIRE UNDERGROUND CABLE TV TELEPHONE U.G. CABLE, SPLICING BOX & MANHOLE	
DE - UG	ELECTRIC U.G. CABLE & MANHOLE	
— 6 "C O —	GAS MAIN & VALVE	×
	WATERMAIN, HYD., GATE VALVE, TAPPING SLEEVE & VALVE SANITARY SEWER, CLEANOUT & MANHOLE	<u> </u>
— — <u> </u>	STORM DRAIN & MANHOLE	
——————————————————————————————————————	COMBINED SEWER & MANHOLE	
	CATCH BASIN, INLET	-
#	YARD BASIN	<u> </u>
— — — a	STORM DRAIN & END SECTION	
-	POST INDICATOR VALVE	- Ø-
⊘	WATER SERVICE SHUTOFF, HYDRANT VALVE BOX MAILBOX	0
* 12 ^{3.45}	POINT ELEVATION (AT X OR END OF LEADER)	671.21
<i>670</i>	CONTOUR LINE	671
	FENCE	
0 0 0	GUARD RAIL	0 0 0
*	STREET LIGHT	*
	SIGN	<u>**</u>
	EX. TREE	
	PR. TREE	(C)

Width of symbol:

Minimum = 24 inches

Special = 36 inches

WB-40 TRUCK TURNING PLAN


★Stroke width:


Minimum = 3 inches Special = 4 inches

INTERNATIONAL SYMBOL OF

ACCESSIBILITY PAVEMENT DETAIL


NOT TO SCALE

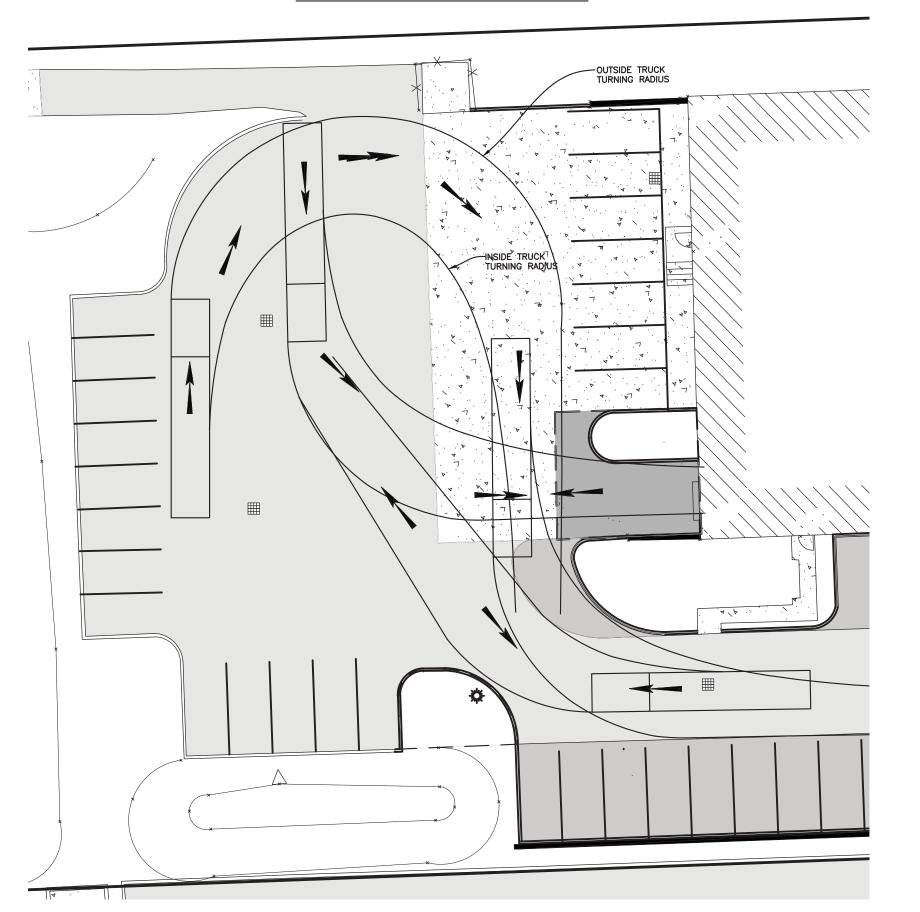

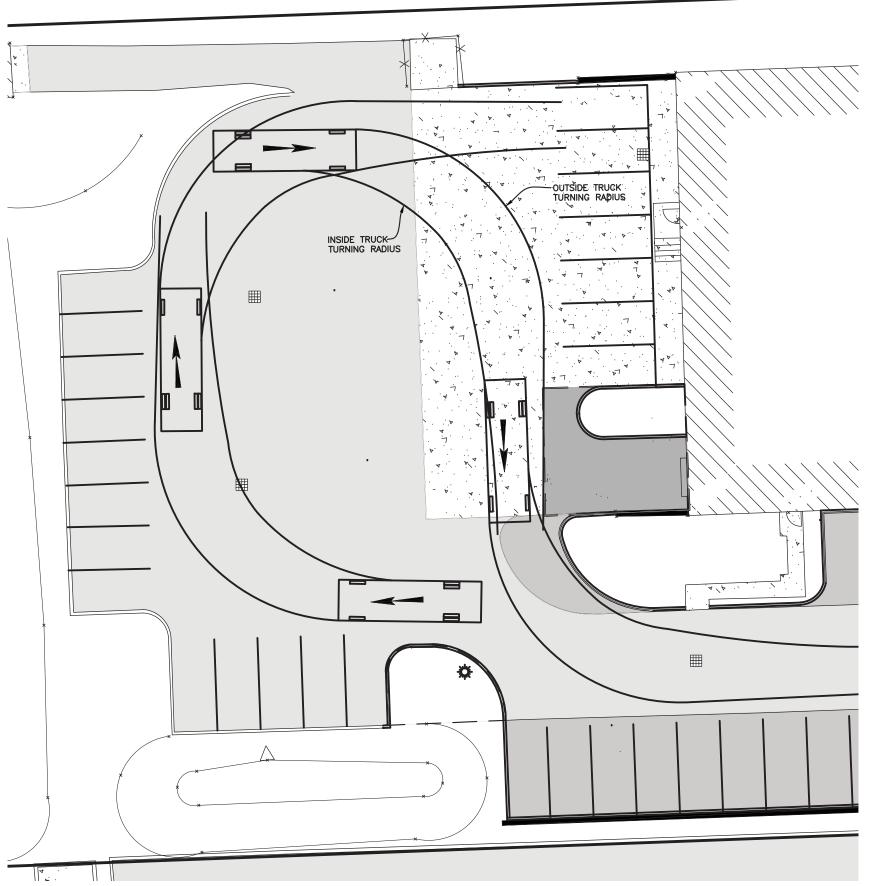

FIRE TRUCK TURNING PLAN

DUMPSTER TRUCK TURNING PLAN

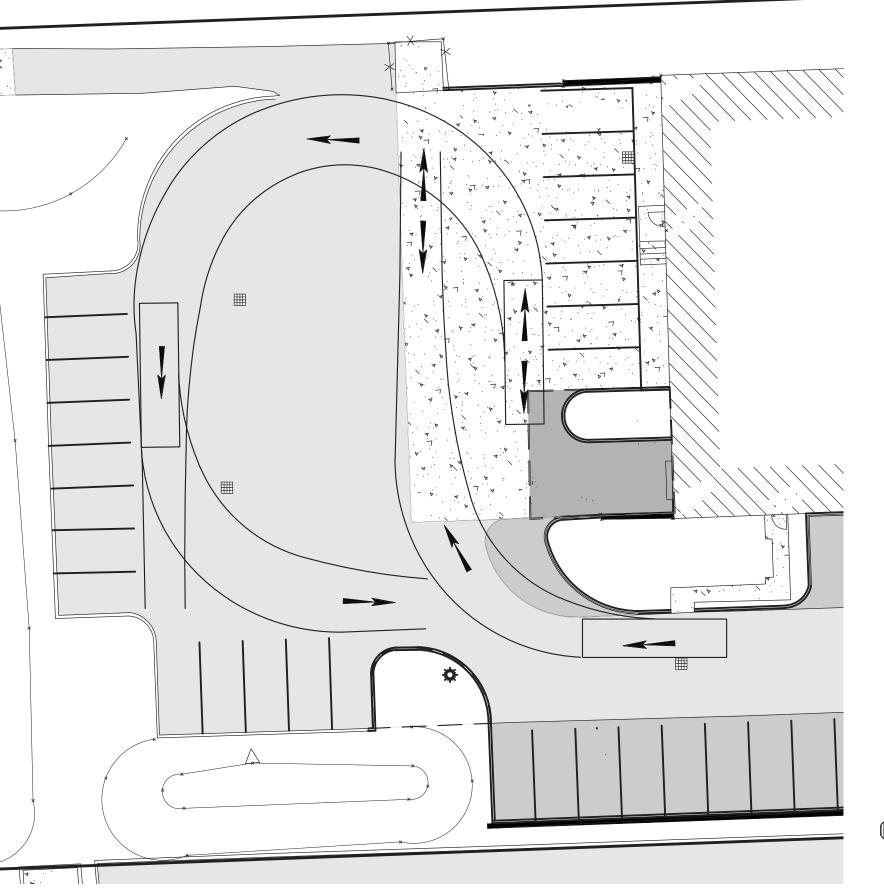

UTILITY INFORMATION, AS SHOWN, INDICATES APPROXIMATE LOCATIONS AND TYPES OF FACILITIES ONLY, AS DISCLOSED TO THIS FIRM BY THE VARIOUS UTILITY COMPANY'S RECORDS. NO GUARANTEE IS GIVEN OR IMPLIED AS TO THE COMPLETENESS OR


CALL MISS DIG



3 WORKING DAYS (EXCLUDING SAT, SUN, AND HOLIDAYS) BEFORE YOU DIG CALL MISS DIG 1-800-482-7171

DRAWING SCALE: 1" = 20' PROJECT MANAGER: JSR, P.E DESIGNED BY: JJS, P.E. DRAWN BY: JJS, P.E. FIELD BY: BH, VA CHECKED BY: TWD/JSR, P

> SHEET NUMBER 5 OF 6

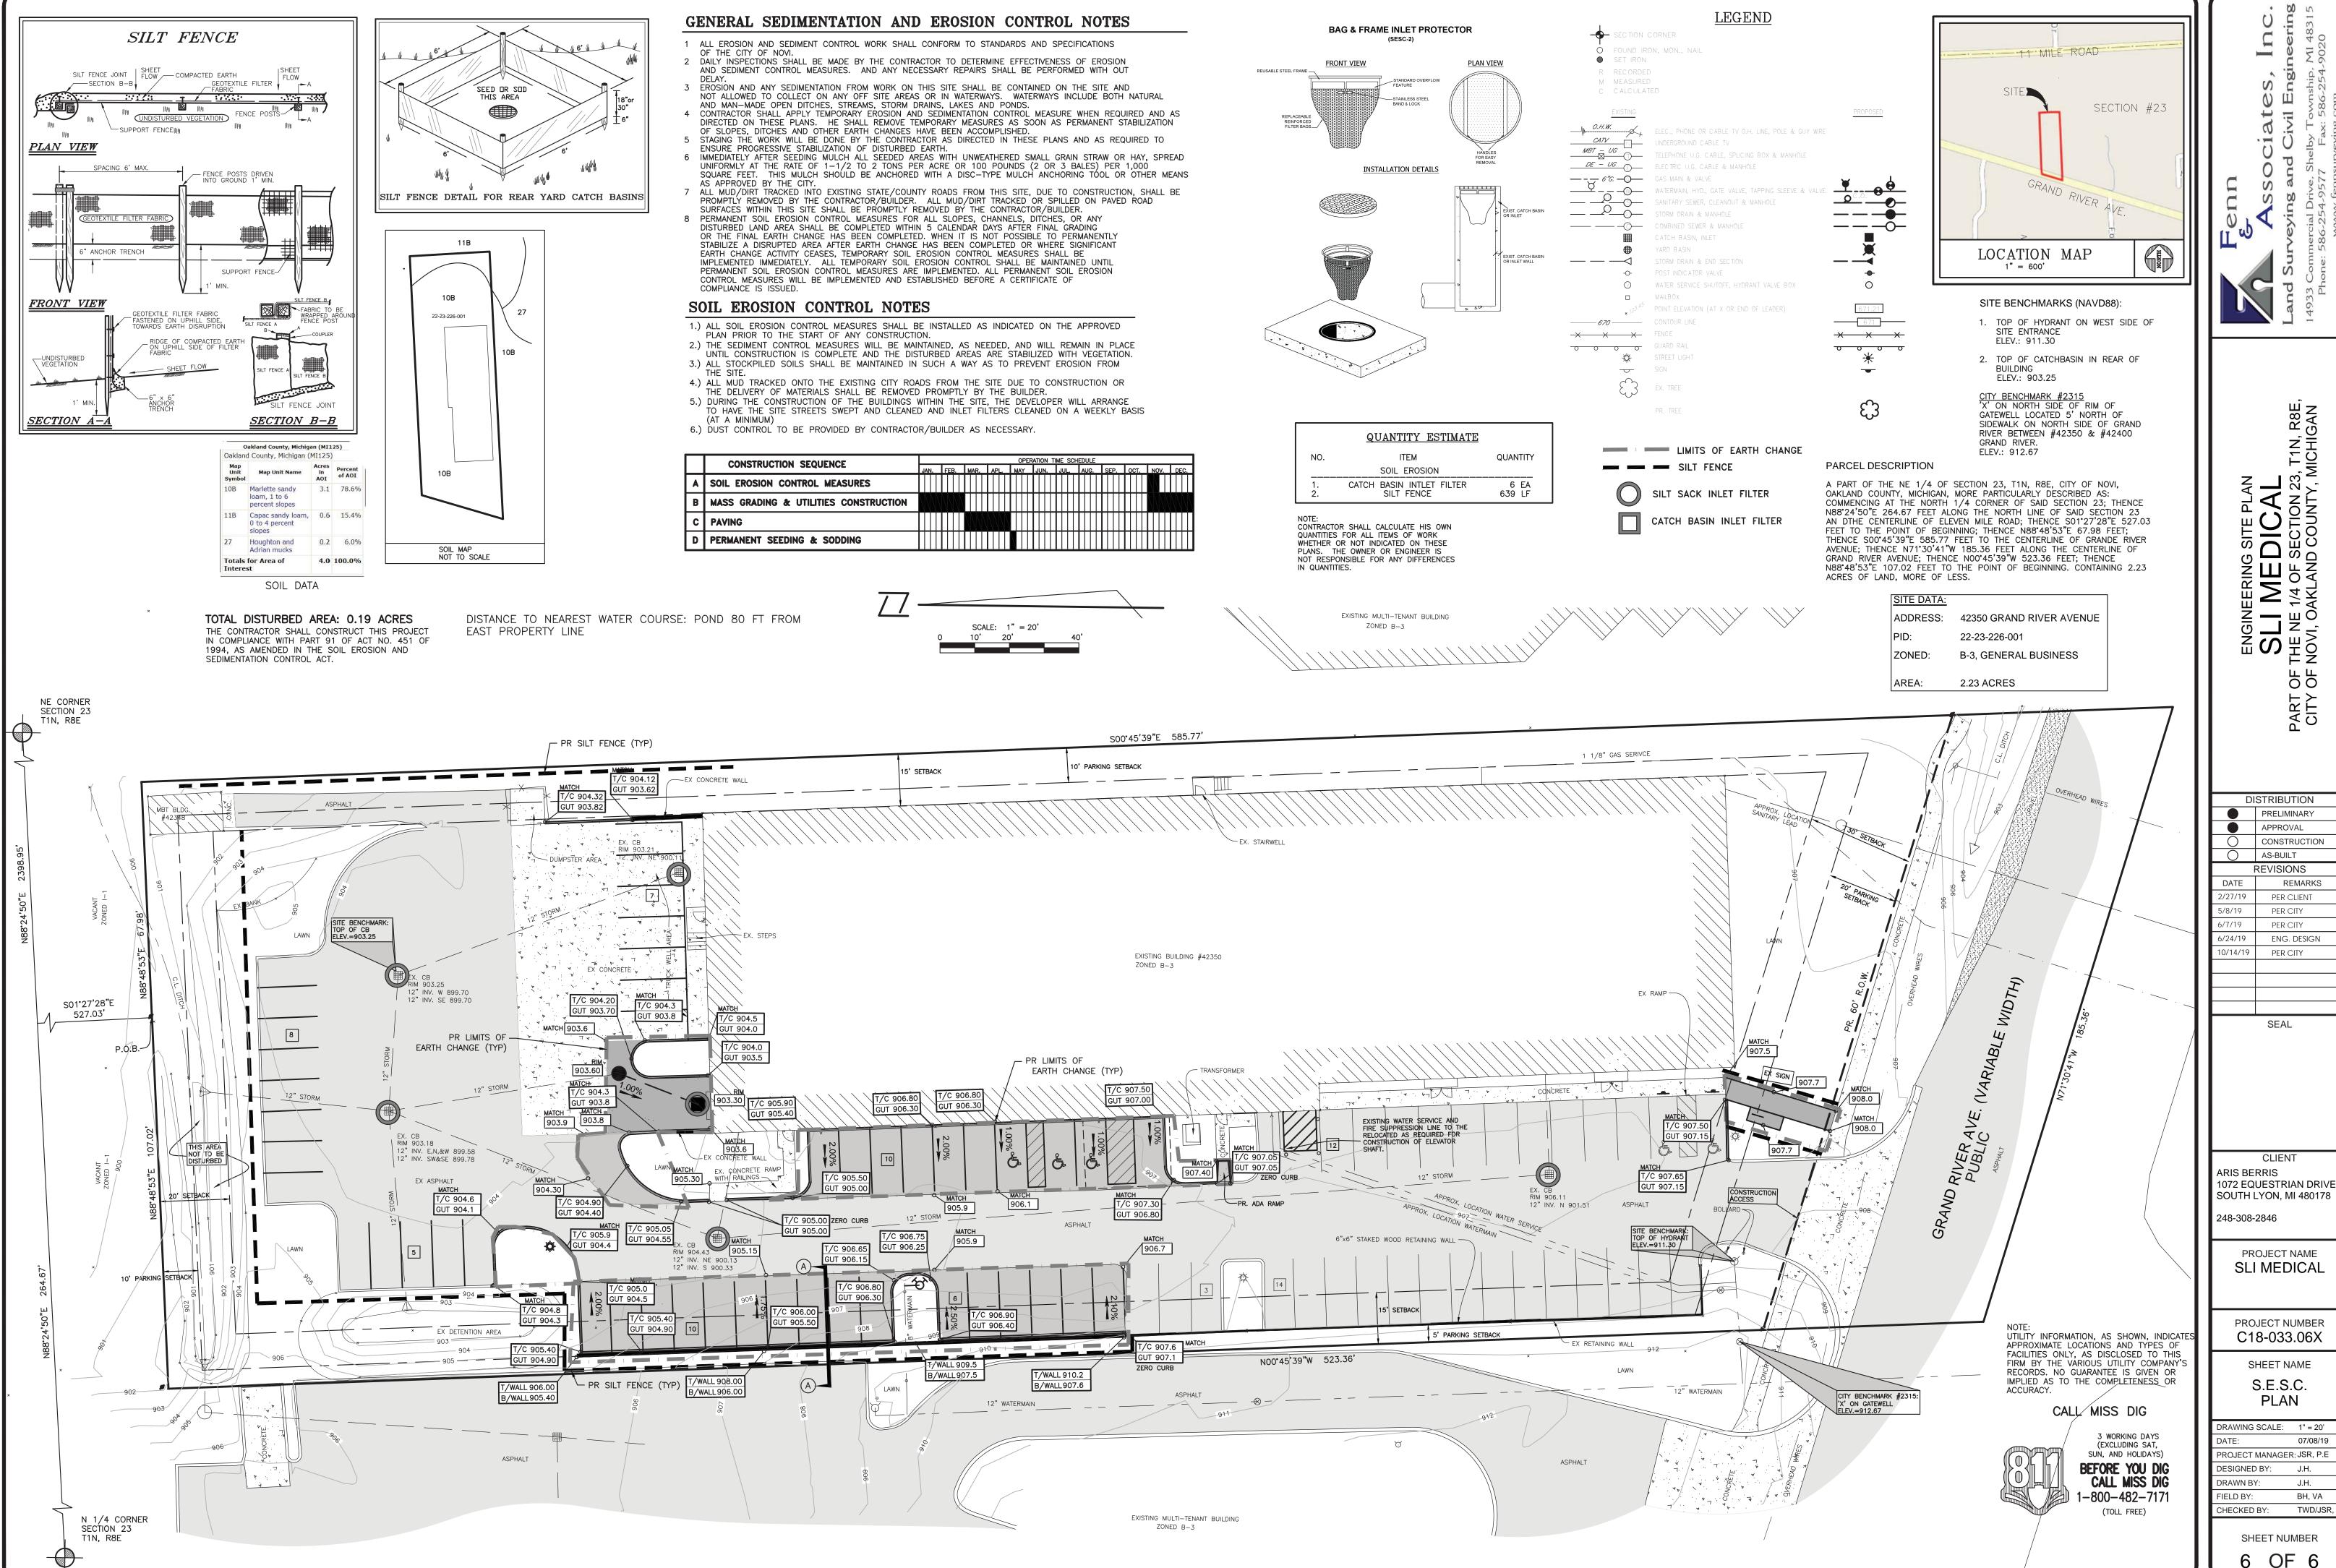

DISTRIBUTION PRELIMINARY APPROVAL CONSTRUCTION AS-BUILT REVISIONS

 $\overline{}$

T1N, R

ĭ Ш ⊬

5/8/19 PER CITY PER CITY 6/24/19 ENG. DESIGN 10/14/19 PER CITY

REMARKS

SEAL

CLIENT

248-308-2846

SLI MEDICAL

PROJECT NAME


PROJECT NUMBER C18-033.06X

SHEET NAME S.E.S.C. PLAN

DRAWING SCALE: 1" = 20' PROJECT MANAGER: JSR, P.E DESIGNED BY: DRAWN BY: FIELD BY: CHECKED BY: TWD/JSR, F

> SHEET NUMBER 6 OF 6

REVISED LANDSCAPE PLAN

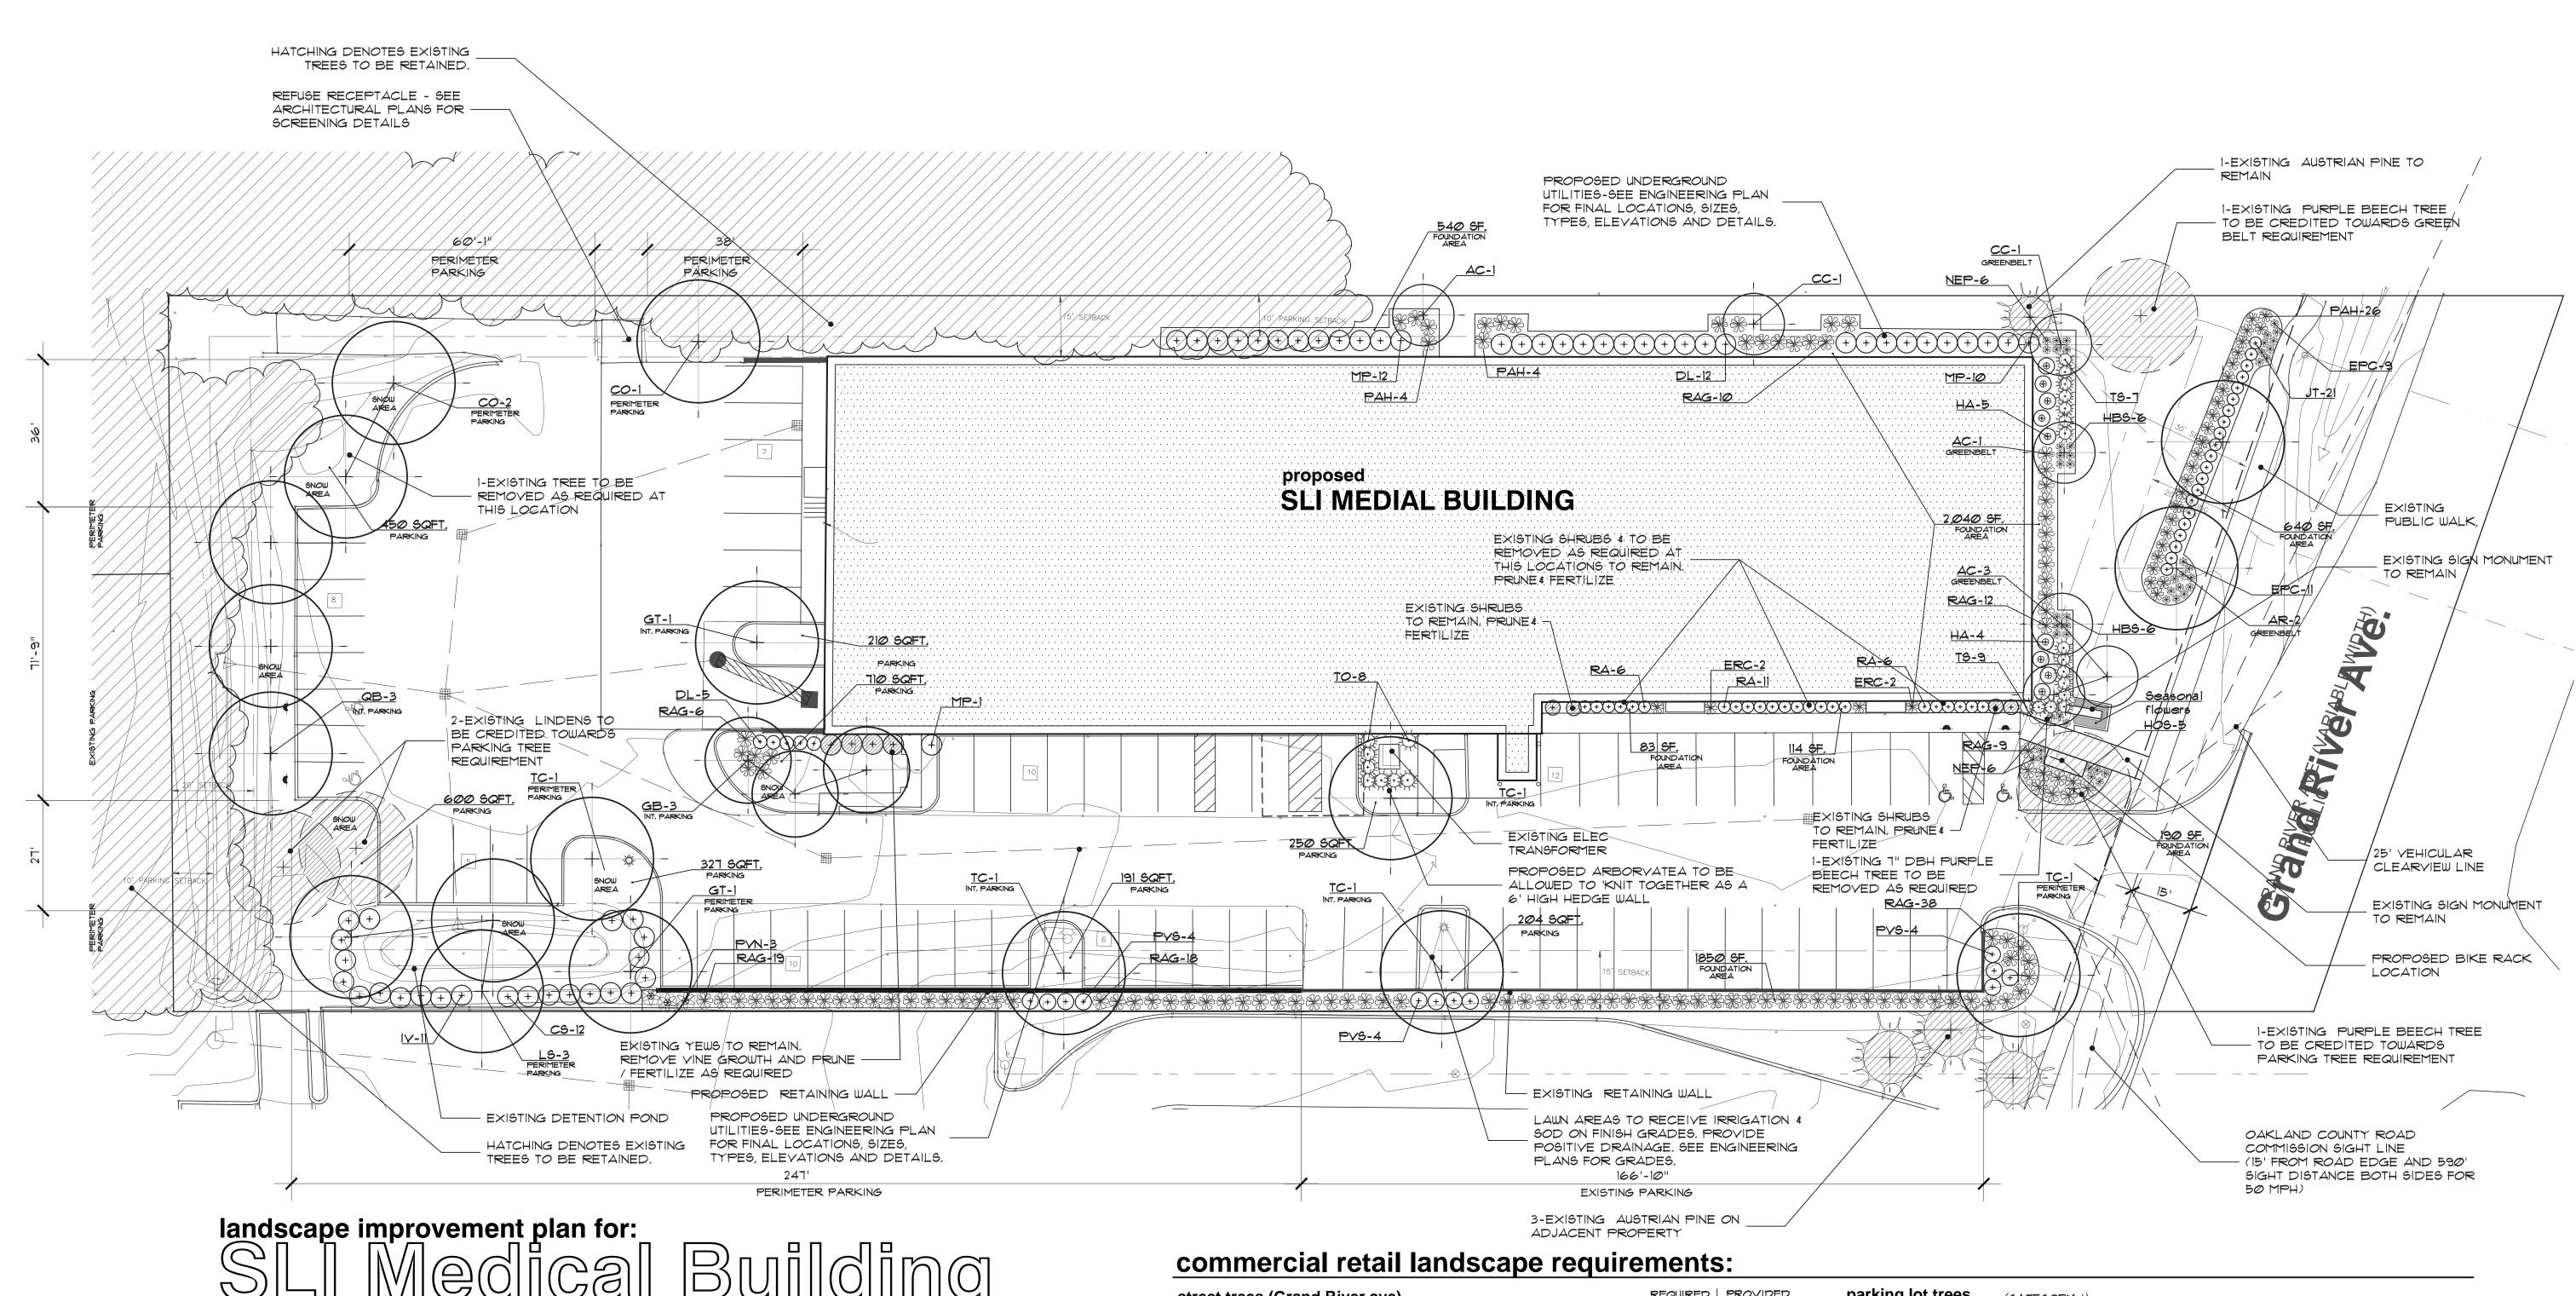


landscape improvement plan for: SLI Medical Building

City of Novi, Michigan

note:

unless noted otherwise, numerical value on landscape quantities specified on plan take precedence over graphic representation.

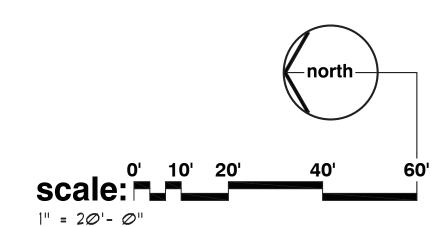

LANDSCAPE WAIVERS GRANTED BY THE PLANNING COMMISSION **ON JUNE 12, 2019**

1. Lack of street trees along Grand River Avenue frontage due to conflicts with existing utilities in right -of-way

2. Not meeting the minimum required parking lot perimeter trees due to a lack of room between the parking and the west property line, provided that the applicant work with the City's landscape architect to maximize number of trees along other areas of the parking lot.

3. Reduction in required greenbelt width along Grand River Avenue due to existing conditions which were previously approved

4. Landscape waiver from Sec. 5.5.3.B.ii for lack of berm along Grand River Avenue, due to existing grading which is not changing

5. Less than 75% of the building foundation is landscaped, and some foundation area landscaping is located away from the building along the

street trees (Grand River ave)	REQUIRED	PROVIDED
TOTAL LIN. FT. OF R.OW. ROAD FRONTAGE-NET	108' <u>+</u>	
ONE (1) 3"DECIDUOUS PER 35 LIN. FT. (108' / 35' PER TREE= 3.08 TREES)	3	(WAIVER #1)
greenbelt (Grand River ave)		•
ROAD FRONTAGE NO PARKING	REQUIRED	PROVIDED
TOTAL LIN. FT. OF R.OW. ROAD FRONTAGE NET	108' <u>+</u>	
ONE (1) 3" DECIDUOUS OR EVERGREEN TREE PER 40 LINFT. (112' / 60' PER TREE= 1.86 TREES)	N 2	2-EXISTING
ONE (1) SUBCANOPY TREE PER 20 LIN. FT	3	3
ROAD FRONTAGE WITH PARKING FRONTAGE	REQUIRED	PROVIDED
TOTAL LIN. FT. OF R.OW. ROAD FRONTAGE NET	40' <u>+</u>	
ONE (1) 3" DECIDUOUS OR EVERGREEN TREE PER 40 LIN	N1	1-EXISTING
FT. (40'/35' PER TREE= 1.14 TREE) ONE (1) SUBCANOPY TREE PER 20 LIN. FT. (40'/20' PER TREE= 2 TREES)	2	2

parking lot trees (CATEGORY-I)		
VEHICULAR ACCESS AREA	32,50	04 <u>+</u> SF.
VEHICULAR AREA FORMULA2,437.8	SF.	
(32,504 SF. × .075 (7.5%) = 2,437.8 SF.)	REQUIRED	PROVIDED
TOTAL AREA OF INTERIOR LANDSCAPE ISLANDS AREA _	2,4Ø1 SF.	2,942+ SF.
TOTAL NO. OF PARKING LOT ISLAND TREES	12 TREES	9-TREES +
(24437.8 SF. LANDSCAPE ISLANDS / 200 = 12.18 TREES	5)	3-EXSITNG
TOTAL NO. OF PERIMETER PARKING TREES	19 TREES	11-TREES (WAIVER #2)
LENGTH OF PERIMETER PARKING		
building foundation	REQUIRED	PROVIDED
BUILDING FOUNDATION LANDSCAPE AREA	4,808 SF.	5457+ SF.
(601' (PERIMETER LIN. FT.) \times 8' = 4,808 SF.)		'
	REQUIRED	PROVIDED
BUILDING PERIMETER (FOUNDATION)60 BLDG FOUNDATION PLANTINGS=75% BLDG TOTAL LENG (601' x .75 (75%)= 450.75' OF PLANTING REQUIRED)	_	473' (78% & WAIVER #5)
BLDG FOUNDATION PLANTINGS PROVIDED		

BLDG FOUNDATION PLANTINGS PROVIDED (WEST BLDG PLANTINGS= 120') (EAST BLDG PLANTINGS= 200') (SOUTH BLDG PLANTINGS= 93') (BERM PLANTINGS= 60')



ARIS BERRIS 1702 EQUESTRIAN DRIVE, SOUTH LYON, MI 480178

project:

SLI MEDICAL BUILDING

City of NOVI

project location:

GRAND RIVER AVE

sheet title:

planting detail

overall landscape

job no./issue/revision date:

LS19.081.06 SPA 6-7-2019 LS19.081.07 REVIEW 7-22-2019 LS19.081.07 SPA 7-29-2019 LS19.081.10 SPA 10-14-2019

checked by:

6-5-2019

notice:

Copyright This document and the subject matter contained therein is proprietary and is not to be used or reproduced without the written permission of Felino Pascual and Associates

Do Not scale drawings. Use figured dimensions only



The location and elevations of existing underground utilities as shown on this drawing are only approximate. no guarante is either expressed or implied as to the completeness of accuracy, contractor shall be exclusively responsible for determining the exact location and elevation prior to the start of construction

project no:

LS19.081.06

sheet no:

plant material list


piant material not								
key	quant. LS-1	botanical name	common name	size	native	comments	unit cost	total
		LARGE AND SMALL DECIDUOUS TREES						
GT	2	GLEDITSIA TRIACANTHOS	HONEYLOCUST	3" BB	NATIVE		\$400	\$8 <i>00</i>
LS	3	LIQUIDAMBAR STYRACIFLUA	AMERICAN SWEETGUM	3" BB	NATIVE		\$400	\$1,200
co	3	CELTIS OCCIDENTALIS	HACKBEERY TREE	3" BB	NATIVE		\$400	\$1200
AR	2	ACER RUBRUM	RED MAPLE	3" BB	NATIVE		\$400	\$8 <i>00</i>
GB	3	GINGKO BILOBA 'PRINCETON SENTRY'	PRINCETON SENTRY MAIDENHAIR TREE	3" BB			\$400	\$1,200
TC	5	TILIA CORDATA 'GREENSPIRE'	GREENSPIRE LINDEN	3" BB			\$400	\$2 <i>,000</i>
QB	3	QUERCUS BI-COLOR	WHITE SWAMP OAK	3" BB	NATIVE	,	\$400	\$1,200
AC	5	AMELANCHIER CANADENSIS	SHADBLOW SERVICEBERRY	8' BB	NATIVE	(MULTI-STEM)	\$250	\$1,250
CC	2	CERSIS CANADENSIS	EASTERN REDBUD	8' BB	NATIVE	(MULTI-STEM)	\$250	\$5 <i>00</i>
							TOTAL	\$10,150
		SHRUBS						
DL	17	DIERVILLA LONICERA	BUSH HONEYSUCKLE	#5 CONT.	NATIVE		\$50	\$85 <i>0</i>
HA	9	HYDRANGEA ANNEBELLE	ANNABELLE HYDRANGEA	#5 CONT.		,	45 Ø	\$450
MP	23	MYRICA PENSYLVANICA	BARBERRY	3' BB	NATIVE	42" O.C.	#5 Ø	\$115 <i>@</i>
JT	21	JUNIPERUS S. 'TAMARISAFOLIA'	TAM'S JUNIPER	24" B.B			45 <i>0</i>	\$1050
RAG	112	RHUS AROMATICA 'GRO-LOW'	GRO-LOW FRAGRANT SUMAC	#3 CONT	HYB. NATIVE		\$5Ø	\$56 <i>0</i> 0
TS	16	TAXUS 'SEBIAN'	SEBIAN YEW	24"-30"BB		32" O.C.	\$5Ø	\$800
TO	8	THUJA OCCIDENTALIS 'TECHNY'	MISSION ARBORVITAE	6' BB		32" O.C.	\$5Ø	\$400
CS	12	CORNUS STOLONIFERA	REDTWIG DOGWOOD	#5 CONT.	NATIVE		\$50	1600
īv	11	ILEX VERTICILLATA	MICHIGAN HOLLY	#5 CONT.	NATIVE		\$5Ø	\$55Ø
RA	23	RIBES ALPINUM	ALPINE CURRANT	#3 CONT.			\$5Ø	\$1,150
							TOTAL	\$12,600
		PERENNIALS AND GRASSES						
ERC	4	EUPATORIUM RUGOSUM 'CHOCOLATE'	JOE PYE WEED	#3 CONT.	HYB. NATIVE		\$15	\$60
PVS	12	PANICUM VIRGATUM 'SHENANDOAH'	SHENANDOAH SWITCH GRASS	*3 CONT.	HYB. NATIVE	36" O.C.	\$15	\$180
PAH	34	PENNISETUM ALOPECUROIDES 'HAMELN'	DWARF FOUNTAIN GRASS	*3 CONT.		36" O.C.	\$15	\$510
HBS	12	HEUCHERA 'BERRY \$MOOTHIE'	BERRY SMOOTHIE CORAL	#1 CONT.	HYB. NATIVE	24" O.C.	\$15	\$180
NEP	12	NEPETA X FAASSENII 'WALKER'S LOW'	WALKER'S LOW CATNIP	#1 CONT.		24" O.C.	\$15	\$180
HOS	5	HOSTA 'PATRIOT'	PATRIOT HOSTA	#1 CONT.	HYB. NATIVE	24" O.C.	\$15	\$ 75
EPC	20	ECHINACEA 'CRAZY PINK'	CRAZY PINK CONE FLOWER	#1 CONT.	HYB. NATIVE	24" O.C.	\$15	\$3 <i>00</i>
PW	3	PANICUM VIRGATUM 'NORTHWIND'	NORTHWIND SWITCH GRASS	*3 CONT.	HYB. NATIVE	36" O.C.	\$15	\$ 45
				_	66% NATIVE		TOTAL	\$153Ø

LANDSCAPE SCREENING (Burning Bush, Viburnum, or Miss TRANSFORMER DOOR FRONT-3' CLEARANCE BOUNDARY AT TRANSFORMER PAD -2' TYP. CLEARANCE BOUNDARY ALONG TRANSFORMER SIDES AND BACK TRANSFORMER -

transformer pad planting detail

A MINIMUM OF 2' SEPARATION BETWEEN TRANSFORMER AND FULL GROWN SHRUBS AND TREES. GROUND COVERS ALLOWED UP TO TRANSFORMER PAD IF MAINTAINED BELOW 4" FULL GROWTH. I TRANSFORMER FACES TOWARDS THE HOUSE, THEN THE SAME CONDITIONS EXIST. NO FULL GROWTH IN FRONT OF THE TRANSFORMER FOR AT LEAST A MINIMUM OF 8'. THERE ARE NO WAIVERS GRANTED TO THE ABOVE CONDITION. DETAIL PER THE DETROIT EDISON COMPANY-SERVICE PLANNING DEPARTMENT (9-17-98)

SEE ENGINEERING PLANS FOR PROPOSED LOCATIONS. TOTAL NUMBER OF TRANSFORMERS AND

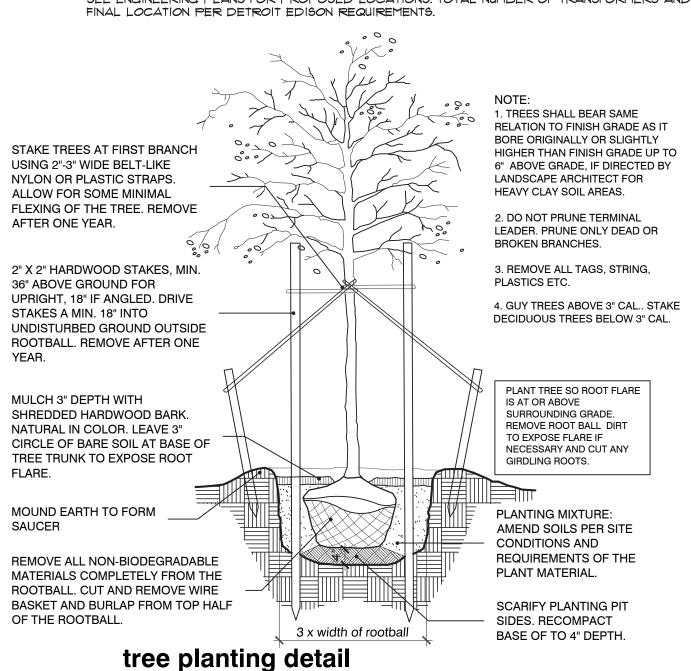

STAKE TREES AT FIRST BRANCH

FLEXING OF THE TREE. REMOVE

USING 2"-3" WIDE BELT- LIKE

NYLON OR PLASTIC STRAPS.

ALLOW FOR SOME MINIMAL

2" X 2" HARDWOOD STAKES,

UPRIGHT, 18" IF ANGLED.

DRIVE STAKES A MIN. 18"

REMOVE AFTER ONE YEAR.

OUTSIDE ROOTBALL

MIN. 36" ABOVE GROUND FOR

INTO UNDISTURBED GROUND

PLANT TREE SO ROOT FLARE IS AT

OR ABOVE SURROUNDING GRADE.

EXPOSE FLARE IF NECESSARY AND

REMOVE ALL NON-BIODEGRADABLE

THE ROOTBALL. CUT AND REMOVE

evergreen planting detail

WIRE BASKET AND BURLAP FROM

TOP HALF OF THE ROOTBALL.

MATERIALS COMPLETELY FROM

REMOVE ROOT BALL DIRT TO

CUT ANY GIRDLING ROOTS.

MOUND EARTH TO FORM

AFTER ONE YEAR.

TOTAL ESTIMATED PLANT MATERIALS COST	\$24,280
TOTAL ESTIMATED IRRIGATION COST	\$4,5 <i>00</i>
TOTAL ESTIMATED SOD COST(100 SQ.YD. X % PER SQ.YD. = 1600)	\$6 <i>00</i>
TOTAL ESTIMATED MULCH COST	\$1,225

1.EVERGREEN TREE SHALL BEAR SAME RELATION TO FINISH GRADE

ABOVE GRADE, IF DIRECTED BY

CLAY SOIL AREAS.

BELOW 12' HEIGHT.

ROOT FLARE.

PLANTING MIXTURE:

AMEND SOILS PER SITE

OF THE PLANT MATERIAL.

SCARIFY PLANTING PIT SIDES

RECOMPACT BASE OF TO 4"

BRANCHES.

AS IT BORE ORIGINALLY OR SLIGHTLY

HIGHER THAN FINISH GRADE UP TO 6

LANDSCAPE ARCHITECT FOR HEAVY

2. DO NOT PRUNE TERMINAL LEADER.

4. GUY EVERGREEN TREES ABOVE 12'

HEIGHT. STAKE EVERGEEN TREE

MULCH 3" DEPTH WITH

SHREDDED HARDWOOD BARK.

CIRCLE OF BARE SOIL AT BASE

CONDITIONS AND REQUIREMENTS

OF TREE TRUNK TO EXPOSE

NATURAL IN COLOR. LEAVE 3"

PRUNE ONLY DEAD OR BROKEN

3. REMOVE ALL TAGS, STRING,

cost estimate summary

TOTAL ESTIMATED PLANT MATERIALS COST	\$24,280
TOTAL ESTIMATED IRRIGATION COST	\$4,500
TOTAL ESTIMATED SOD COST(100 SQ.YD. X % PER SQ.YD. = 1600)	4600
TOTAL ESTIMATED MULCH COST	\$1,225
TOTAL ESTIMATED LANDSCAPE COST	\$3 <i>0,60</i> 5

general landscape notes:

1. LANDSCAPE CONTRACTOR SHALL VISIT THE SITE, INSPECT EXISITING CONDITIONS, REVIEW PROPOSED PLANTINGS AND RELATED WORK. CONTACT THE OWNER AND/OR LANDSCAPE ARCHITECT WITH ANY CONCERNS OR DISCREPANCY BETWEEN THE PLAN, PLANT MATERIAL LIST, AND/OR SITE CONDITIONS.

2. PRIOR TO BEGINNING OF CONSTRUCTION ON ANY WORK, CONTRACTORS SHALL VERIFY LOCATIONS OF ALL ON SITE UTILITIES. GAS, ELECTRIC, TELEPHONE, CABLE TO BE LOCATED BY CONTACTING MIGS DIG 1-800-482-7171. ANY DAMAGE OR INTERRUPTION OF SERVICES SHALL BE THE RESPONSIBILITY OF THE CONTRACTOR, COORDINATE ALL RELATED WORK ACTIVITIES WITH OTHER TRADES AND REPORT ANY UNACCEPTABLE JOB CONDITIONS TO OWNER PRIOR TO COMMENCING

3. NUMERICAL VALUE ON THE LANDSCAPE QUANTITIES SPECIFIED ON THE PLAN TAKE PRECEDENCE OVER GRAPHIC REPRESENTATION, VERIFY ANY CONCERN-DISCREPANCY WITH LANDSCAPE ARCHITECT.

4. ALL CONSTRUCTION AND PLANT MATERIAL LOCATION TO BE ADJUSTED ON

5. ALL SUBSTITUTIONS OR DEVIATIONS FROM THE LANDSCAPE PLAN MUST BE APPROVED IN WRITING BY CITY OF NOVI.

6. ALL LARGE TREES AND EVERGREENS TO BE STAKED, GUYED AND WRAPPED AS DETAILED, SHOWN ON PLAN.

7. PLANT BEDS TO BE DRESSED WITH MIN. 4" OF FINELY DOUBLE SHREDDED HARDBARK MULCH. 8. DIG SHRUB PITS I' LARGER THAN SHRUB ROOT BALLS AND TREE PITS 2' LARGER THAN ROOT BALL. BACK FILL WITH ONE PART TOP SOIL AND ONE

PART SOIL FROM EXCAVATED PLANTING HOLE. 9. NATURAL COLOR, FINELY SHREDDED HARDWOOD BARK MULCH REQUIRED FOR ALL PLANTINGS.

10. REMOVE ALL TWINE, WIRE AND BURLAP FROM TREE AND SHRUB EARTH BALLS, AND FROM TREE TRUNKS. 4" THICK BARK MULCH FOR TREES IN 4' DIA. CIRCLE WITH 3" PULLED AWAY FROM TRUNK, 4" THICK BARK MULCH FOR

11. PLANT MATERIAL QUALITY & INSTALLATION SHALL BE IN ACCORDANCE WITH THE CURRENT AMERICAN ASSOCIATION OF NURSERYMEN LANDSCAPE

SHRUBS AND 4" THICK BARK MULCH FOR PERENNIALS.

AND FERTILIZER BEFORE PLANT INSTALLATION.

12. PROVIDE PEAT SOD FOR ALL NEW AND DISTURBED LAWN AREAS UNLESS

NOTED OTHERWISE. 13. ALL PLANTING AREAS TO BE PREPARED WITH APPROPRIATE SOIL MIXTURES

14. PLANT TREES AND SHRUBS GENERALLY NO CLOSER THAN THE FOLLOWING DISTANCES FROM SIDEWALKS, CURBS AND PARKING STALLS:

a). SHADE TREES_ b). ORNAMENTAL AND EVERGREEN TREES (CRAB, PINE, SPRUCE, ETC.) c). SHRUBS THAT ARE LESS THAN I FOOT TALL AND WIDE AT MATURITY

15. NO TREES OR EVERGREENS TO BE INSTALLED OVER ANY PROPOSED OR EXISTING UTILITY LINES AS SHOWN ON THE OVERALL LANDSCAPE PLAN. SEE ENGINEERING PLANS FOR LOCATION AND DETAILS.

16. ALL LAWN AREAS AND LANDSCAPE BEDS TO BE FULLY IRRIGATED WITH AN AUTOMATIC UNDERGROUND SYSTEM, IRRIGATION SYSTEM TO HAVE SEPARTE ZONES FOR LAWN AREAS, PARKING ISLANDS, AND SHRUB BEDS WITH DIFFERENT CONTROL MOISTURE LEVEL ADJUSTMENT PER ZONE AS REQUIRED

17. UNLESS NOTED OTHERWISE, LANDSCAPE BEDS ADJACENT TO LAWN TO RECIEVE EDGING. EDGING SHALL BE 4" X 1/8" METAL (FINISH BLACK OR GREEN) OR APPROVED EQUAL AND TO BE INSTALLED WITH HORIZONTAL METAL STAKES AT 32" O.C. OR PER MANUFACTERER'S SPECIFICATION.

18. ALL NEW PARKING ISLANDS AND LANDSCAPE BEDS ADJACENT AND NEXT TO BUILDING SHALL BE EXCAVATED OF ALL BUILDING MATERIALS AND POOR SOILS A MIN. OF 16"-18" DEPTH. BACK FILL WITH GOOD, MEDIUM TEXTURED PLANTING SOILS. ADD A MIN. 4" OF TOPSOIL OVERFILL TO FINISH GRADE. PROVIDE POSITIVE DRAINAGE.

19. WATERING OF ALL PLANTS AND TREES TO BE PROVIDED IMMEDIATELY AND MULCHING WITHIN 24 HOURS AFTER INSTALLATION.

20. ALL TREE PITS TO BE TESTED FOR PROPER DRAINAGE PRIOR TO TREE PLANTING. PROVIDE APPROPRIATE DRAINAGE SYSTEM AS REQUIRED IF THE TREE PIT DOES NOT DRAIN SUFFICIENTLY.

21. ALL LANDSCAPE PLANT MATERIALS AND IRRIGATION SHALL BE GUARANTEE FOR A PERIOD OF TWO YEAR AFTER THE CITY APPROVAL INSPECTION DATE.

landscape maintenance notes:


LANDSCAPE MAINTENANCE PROCEDURES AND FREQUENCIES TO BE FOLLOWED SHALL BE SPECIFIED ON THE LANDSCAPE PLAN, ALONG WITH THE MANNER IN WHICH THE EFFECTIVENESS, HEALTH AND INTENDED FUNCTIONS OF THE VARIOUS LANDSCAPE AREAS ON THE SITE WILL BE ENSURED.

1. LANDSCAPING SHALL BE KEPT IN A NEAT, ORDERLY AND HEALTHY GROWING CONDITION, FREE FROM DEBRIS AND REFUSE.

2. PRUNING SHALL BE MINIMAL AT THE TIME OF INSTALLATION, ONLY TO REMOVE DEAD OR DISEASED BRANCHES. SUBSEQUENT PRUNING SHALL ASSURE PROPER MATURATION OF PLANTS TO ACHIEVE THEIR APPROVED PURPOSE.

3. ALL DEAD OR DISEASED PLANT MATERIAL SHALL BE REMOVED AND REPLACED WITHIN THREE (3) MONTHS AFTER IT DIES OR IN THE NEXT PLANTING SEASON, WHICHEVER OCCURS FIRST. THE PLANTING SEASON FOR DECIDUOUS PLANTS SHALL BE BETWEEN MARCH IS AND NOVEMBER 15 OR UNTIL THE PREPARED SOIL BECOMES FROZEN, THE PLANTING SEASON FOR EVERGREEN PLANTS SHALL BE BETWEEN MARCH I AND JUNE 1. PLANT MATERIAL INSTALLED TO REPLACE DEAD OR DISEASED MATERIAL SHALL BE AS CLOSE AS PRACTICAL TO THE SIZE OF THE MATERIAL IT IS INTENDED TO REPLACE.

4. THE APPROVED LANDSCAPE PLAN SHALL BE CONSIDERED A PERMANENT RECORD AND INTEGRAL PART OF THE SITE PLAN APPROVAL. UNLESS OTHERWISE APPROVED IN ACCORDANCE WITH THE AFOREMENTIONED PROCEDURES, ANY REVISIONS TO, OR REMOVAL OF, PLANT MATERIALS WILL PLACE THE PARCEL IN NON-CONFORMITY WITH THE APPROVED LANDSCAPE PLAN, AND SHALL BE VIEWED AS A VIOLATION OF THIS ORDINANCE AND THE AGREED UPON TERMS OF THE FINAL SITE PLAN APPROVAL.

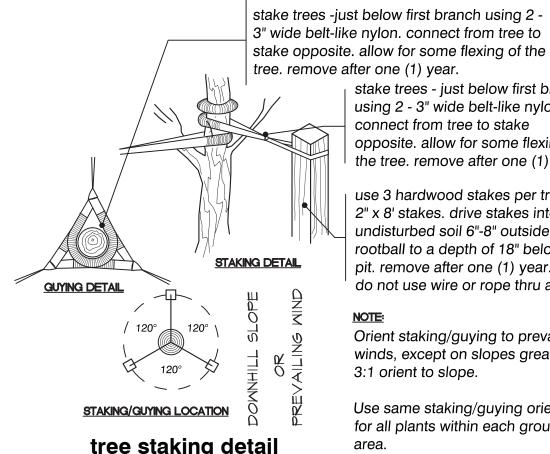

opposite. allow for some flexing of the tree. remove after one (1) year. use 3 hardwood stakes per tree. 2" x 2" x 8' stakes. drive stakes into


undisturbed soil 6"-8" outside of rootball to a depth of 18" below tree pit. remove after one (1) year. do not use wire or rope thru a hose

stake trees - just below first branch

using 2 - 3" wide belt-like nylon.


Orient staking/guying to prevailing winds, except on slopes greater than 3:1 orient to slope.

Use same staking/guying orientation for all plants within each grouping or

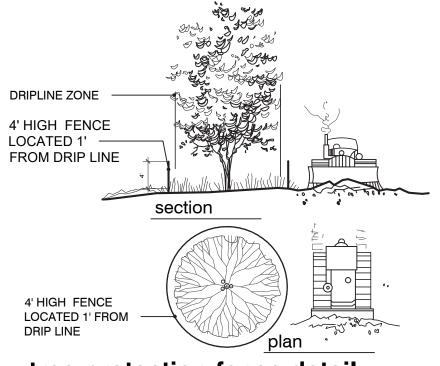

tree protection fence detail

1. SHRUB SHALL BEAR SAME RELATION TO FINISH GRADE AS IT BORE ORIGINALLY OR SLIGHTLY HIGHER THAN FINISH GRADE UP TO 4" ABOVE GRADE, IF DIRECTED BY LANDSCAPE ARCHITECT FOR HEAVY CLAY SOIL AREAS. 2. PRUNE ONLY DEAD OR BROKEN BRANCHES. 3. REMOVE ALL TAGS, STRING, MULCH 2" DEPTH WITH SHREDDED PLASTICS AND OTHER MATERIALS PLANTING MIXTURE: AMEND SOILS PER SITE CONDITIONS AND

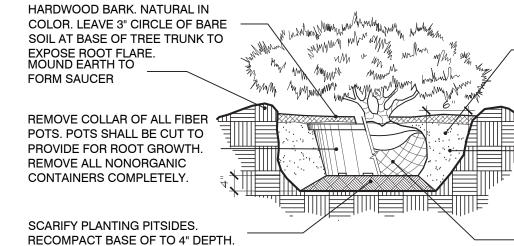

shrub planting detail

REQUIREMENTS OF THE PLANT MATERIAL. SHALL HAVE ENTIRE BED MASS EXCAVATED AND BACKFILLED WITH APPROVED PLANT MIX. PLANTS SHALL NOT BE INSTALLED IN INDIVIDUAL HOLES. REMOVE ALL NON-BIODEGRADABLE MATERIALS COMPLETELY FROM THE ROOTBALL. CUT AND REMOVE WIRE

BASKET AND BURLAP FROM TOP

HALF OF THE ROOTBALL.

SHREDDED HARDWOOD BARK MULCH SHALL BE NEUTRAL IN PLANTING MIXTURE 12" DEPTH SUBGRADE

MIN. 1 1/2 " - 2" DEPTH DOUBLE

perennial planting detail

Plant Material List, Planting Details and Notes



ARIS BERRIS 1702 EQUESTRIAN DRIVE, SOUTH LYON, MI 480178

project:

SLI MEDICAL BUILDING

project location: City of NOV

GRAND RIVER AVE

sheet title:

plant material list and planting details

job no./issue/revision date: LS19.081.06 SPA 6-7-2019

LS19.081.07 REVIEW 7-22-2019 LS19.081.07 SPA 7-29-2019 LS19.081.10 SPA 10-14-2019

checked by:

6-5-2019

notice: Copyright This document and the subject matter contained therein is proprietary and is not to be used or reproduced without the written permission of Felino Pascual

and Associates Do Not scale drawings. Use figured dimensions only



nderground utilities as shown on this is either expressed or implied as to the completeness of accuracy, contractor shall be exclusively responsible for determining the exact location and elevation prior to the start

project no: LS19.081.06

of construction

sheet no:

APPLICANTS RESPONSE LETTER





October 15th, 2019

Sri Ravali Komaragiri Novi City Planning & Zoning 45175 W 10 Mile Rd Novi, MI 48375

Re: Plan Review Center Report
Planning Review, dated 10/1/19
SLI Medical Office
42350 Grand River Avenue
Novi, MI 48375
JSP 18-74

The engineering plans have been revised per your review comments dated October 1st, 2019. The landscape review comments will be provided by the Landscape Architect in a separate letter. Our responses to your comments are as follows:

Planning Review

1. The applicant shall provide a truck circulation diagram as noted in the Traffic review letter at the time of final site plan.

A fire truck turning template, a dumpster/garbage truck turning template, and a WB-40 truck turning template are shown on sheet 5 of the revised plans.

 The applicants architect should indicate if additional handicap spaces would be required based on the use and try to accommodate those spaces at this time.
 The Building Department indicates that a minimum of 20% of parking required for physical therapy use should be barrier free.

Physical therapy accounts for 1, 150 square feet of the total proposed building area. Per the city ordinance, seven (7) parking spaces are required for this size area. 20% of those seven (7) spaces equates to two (2) ADA spaces.

The total parking area had 75 spaces. Per federal requirements, three (3) of those 75 spaces should be ADA spaces.

A total of five (5) ADA spaces are being proposed for this site. This includes the three (3) federally required ADA spaces and the two (2) additional ADA spaces for the physical therapy portion of the building.

To require 20% of the entire parking area to be ADA spaces is unreasonable given the relatively small portion of the building that is proposed for physical therapy use.

These calculations are show on sheet 2.

3. Please clarify if any additional site lighting or building lighting is proposed. If yes, a lighting and photometric plan as noted in the plan review chart is required at this time.

No new lighting is proposed for this site. Note has been added to plans.

Planning Review Chart

1. Parking setback screening – Screening is deficient.

See landscape review letter and plan by-others.

2. End Islands – Required some revisions.

Islands have been revised. See traffic review comments for more information.

3. Barrier Free Spaces – Two van accessible spaces to the north do not provide a safe and convenient access to building. Are additional barrier free spaces required for the type of medical use located in the building? Please clarify.

An ADA ramp has been proposed near these north ADA spaces.

See item 2 under Planning Review for ADA parking explanation.

4. Bicycle Parking Lot Layout – Layout not provided.

A bike rack detail has been added to sheet 5.

5. Exterior Lighting – A lighting plan is required if additional lighting is proposed.

No new lighting is proposed for this site. Note has been added to plans.

6. Roof top equipment and wall mounted utility equipment – The applicant should get a façade permit for rooftop equipment screening.

Applicant will apply and obtain for a façade permit for rooftop equipment screening if new rooftop equipment is deemed necessary. Note has been added to sheet 2.

7. General layout and dimension of proposed physical improvements – They do not provide dimensions for the parking improvements.

Overall improvement dimensions have been added to sheet 2.

8. Lighting and Photometric Plan – Submit a lighting plan or indicate if additional lighting is not proposed.

No new lighting is proposed for this site. Note has been added to plans.

Engineering Review

1. Revise the plan set to reference at least one City established benchmark.

A city established benchmark has been added to the plans.

2. Provide a note on the plans that all work shall conform to the current City of Novi standards and specifications.

A note has been added to the plans.

3. Provide the City's standard detail sheets for storm sewer (2 sheets, rev. 2.16.19) and paving (2 sheets, rev. 3.5.18) at the time of the stamping set submittal.

Detail sheets are attached.

4. The attached Non-Domestic User Survey form shall be submitted to the City so it can be forwarded to Oakland County.

The applicant will complete and submit the Non-domestic User Survey.

5. The dedication of the master-planned 60-foot half width right-of-way along Grand River Avenue is requested for the project.

The 60-foot half width right-of-way is proposed to be dedicated and shown as such on the plans.

6. Provide a note along with the traffic control sign table on sheet 5 stating all traffic signage will comply with the current MMUTCD standards.

Note has been added to sheet 5.

7. Provide a note stating if dewatering is anticipated or encountered during construction a dewatering plan must be submitted to the Engineering Division for review.

A note has been added to the plans.

8. Show all existing watermain/leads, sanitary sewer/leads and associated easement on the plans to ensure no permanent structures interfere with the utilities or easements.

Existing utilities and leads are shown on the plans. Title work has been requested from the applicant to determine existing easement locations.

9. Provide the watermain length, diameter, and material type where the hydrant is being relocated.

Proposed watermain information has been added to sheet 4.

10. Label the finished grade for the relocated hydrant.

Finished grade of the relocated hydrant is shown on sheet 4.

11. Provide a schedule listing the casting type and other relevant information for each proposed storm structure on the utility plan. Round castings shall be provided on all catch basins except curb inlet structures.

Since only two (2) storm structure are proposed, relevant information is listed at each structures callout on sheet 4. Casting information has been added.

12. Indicate the amount of pavement that is existing and the amount of pavement that is proposed. If the difference is determined by the engineering department to be negligible, then no additional storm water management requirements will be requested. If the additional amount of pavement is deemed to be significant increase in impervious surfaces then the site will be required to meet the City's current storm water management standards.

Existing and proposed pavement amounts are listed on sheet 4. All additional parking was part of the 1994 site plan approval conditions.

13. The city requires parking lots to be curbed as outlined in Section 11-239(b) of the design and construction standards. Provide curbs for the entire parking lot.

Proposed curbs have been added to the existing parking lot.

14. A sidewalk easement is requested for the portion of the sidewalk along Grand River Avenue that lies outside the right-of-way.

A sidewalk easement has been added to sheet 2.

15. Provide additional spot grades for the proposed sidewalk connection to the building.

Grades are shown on sheet 4.

16. The two proposed end islands must be 3 feet shorter than the adjacent 19-foot parking stalls.

Dimensions have been added to these areas on sheet 2.

17. Sheet 4 shall be signed and sealed by the design engineer responsible for the proposed retaining wall design and all associated calculations.

To be provided.

18. If the proposed retaining wall is within an existing easement, a license agreement will be required.

Title work has been requested from the applicant to determine existing easement locations. A license agreement will be obtained if necessary.

19. A note on sheet 4 indicates that the pavement on the north side of the site shall be extended 2 feet towards the swale. The current paving plan does not show this extension. Either remove the note of show this extension of paving on the plans.

Note has been removed.

Traffic Review

1. Truck turning movement patterns should be provided to shown that the trash receptacle locations do not interfere with the use of the adjacent proposed parking spaces.

A fire truck turning template, a dumpster/garbage truck turning template, and a WB-40 truck turning template are shown on sheet 5 of the revised plans.

2. The applicant could also secure a shared parking agreement with the neighboring property in case of overflow in the future.

The applicant will obtain a shared parking agreement if necessary.

The barrier free parking requirement for a Physical therapy building should be applied to the parking for the building as a whole, not a subsection based on PT area.

To require 20% of the entire parking are to be ADA spaces is unreasonable given the relatively small portion of the building that is proposed for physical therapy use.

See item 2 under Planning Review for ADA parking explanation.

4. Note that all end islands adjacent to the travel way shall be constructed three (3) feet shorter that the adjacent parking space per Section 5.2.12 of the city's zoning ordinance. The island that is interior to the parking bay on the west side of the site may be extended to be flush with the parking spaces on either side of it. The island with the sidewalk on the east side of the parking lot next to the loading zone may remain at its current length as the island is more that three (3) feet shorter than the loading zone area adjacent to it.

The islands have been revised as indicated above. Additional dimensions have been added to sheet 2.

5. The applicant has indicated bicycle parking on the site plans. A detail of the layout has been provided, however, a bike rake has not been detailed and should be provided to ensure compliance with the city's zoning ordinance.

A bike rack detail has been added to sheet 5.

6. The bike rake must be a minimum of 36" tall.

A bike rack detail has been added to sheet 5.

7. Section 5.16.1.E of the city's zoning ordinance required that the bicycle parking be no more than 120 feet from the entrance being served or the parking space nearest that entrance. The applicant should dimension this distance to ensure that the bicycle parking location meets this requirement.

This dimension is show on sheet 2.

8. The applicant has indicated proposed sidewalk widths. The location of proposed ramps should also be included. The proposed barrier free parking spaces do not have a ramp at the first available sidewalk, according to the site plan. The

applicant should also consider providing a ramp at the sidewalk on the northwest side of the building.

An ADA ramp has been added to the first available sidewalk near these barrier free spaces. The existing sidewalk at the northwest side of the building is an existing ramp with handrails.

9. The applicant has provided a signing quantities table indicating the number of each proposed sign and its size. MMCTCD sign codes should be included as well.

MMUTCD codes and note have been added to sheet 5.

Please contact us if you have any questions.

Sincerely,

Jeffrey S. Rizzo, PE Fenn & Associates

Mr. Rick Meader, Landscape Architect City of Novi Community Development 45175 West Ten Mile Road Novi, MI 48375

RE: SLI Medical Building Landscape Review, Job # jsp18-0074

Dear Mr. Meader:

In response to the city landscape review comments dated September 17, 2019, please see our revised landscape plans for Manchester, Job No. LS18.081.10, dated 10-14-2018, sheets LS-1 through LS-2 for details. We offer the following comments below.

"LANDSCAPE WAIVERS GRANTED BY THE PLANNING COMMISSION ON JUNE 12, 2019", has been copied to sheet LS-1.

Ordinance Considerations

Existing Soils (Preliminary Site Plan checklist #10, #17)

1.(Noted) Provided

Existing and proposed overhead and underground utilities, including hydrants.(LDM 2.e.(4))

1.(Noted) Provided

Existing Trees (Sec 37 Woodland Protection, Preliminary Site Plan checklist #17 and LDM 2.3 (2))

1. 1-7" dbh Purple Beech tree is proposed to be removed due to the required pedestrian walk connection. See site survey for location

Adjacent to Residential - Buffer (Zoning Sec. 5.5.3.B.ii and iii)

1.(Noted) Property is not adjacent to Residential.

Right-of-Way Landscape Screening (Zoning Sec. 5.5.3.B)

- 1. Clear vision zone at Grand River per OCRC standards
- 2. (Noted) Calculations and all required trees are provided.
- 3. (Noted) A landscape waiver was granted by the Planning Commission was granted to not plant the required street trees as there is insufficient room in the right-of-way for them.

Parking Lot Interior (Zoning Sec 5.5.3.C)

- 1. (Noted) Based on the vehicular use area, 2,438sf of landscape area and 12 interior trees are required. 2,943sf of area and 12 trees are proposed.
- 2. Move the tree located in the small greenspace near the transformer to a position in front of the transformer



Parking Lot Perimeter (Zoning Sec 5.5.3.C)

- 1. Updated parking lot perimeter to 680lf. Based on this, the calculation has been updated to 19 trees required and 11 provided.
- 2. (Noted) A waiver was granted due to the lack of room on the site to provide all of the required trees.

Building Foundation Landscape (Zoning Sec 5.5.3.D.)

- 1. Revised the net building perimeter to 601lf, and 4,808sf required. Updated calculations accordingly.
- 2. (Noted) A landscape waiver was granted to not have 75% of the building foundation landscaped and to locate some of the foundation area away from the base of the building, on the front berm.
- 3. AllI foundation landscape areas are in SF.
- 4. Added additional landscaping (shrubs, perennials, grasses, annuals, ornamentals, etc) to meet the required foundation landscape area.

<u>Loading Zone screening (Zoning Sec. 3.14, 3.15, 4.55, 4.56, 5.5)</u> (Noted)

Plant List (LDM 2.h. and t., 4)

- 1. Added more native species to reach at least 50% native species.
- 2. Replaced the privet with viburnums.
- 3. Revise the cost of ornamentals to \$250 each and grasses to \$15 each.

Planting Notations and Details (LDM)

- 1. Revise General Landscape Note #5 to add "in writing" after "approved".
- 2. Note#21 (LS-2), added a note stating that the landscaping must be guaranteed for 2 years after city approval
- 3. Revised Maintenance Note #3 to read 3 months, not 6 months.

Storm Basin Landscape (Zoning Sec 5.5.3.E.iv and LDM 1.d.(3)

1. Replaced 1-dogwood species for Michigan holly

Irrigation (LDM 1.a.(1)(e) and 2.s)

1. Irrigation plan will be provided during final stamping set.

Snow Deposit (LDM.2.q.)

Provided

Corner Clearance (Zoning Sec 5.9)

1. Clear vision zone at Grand River has been shown and no proposed trees or shrubs are located within that zone.

Please do not hesitate to contact me should you have any questions or comments.



Felino A Pascual, RLA