

COMMUNITY DEVELOPMENT DEPARTMENT

45175 Ten Mile Road Novi, MI 48375 (248) 347-0415 Phone (248) 735-5600 Facsimile www.cityofnovi.org

ZONING BOARD OF APPEALS STAFF REPORT

FOR: City of Novi Zoning Board of Appeals ZONING BOARD APPEALS DATE: May 11, 2021

REGARDING: 41321 Llewelyn Drive, Parcel # 50-22-36-352-004 (PZ21-0024)

BY: Larry Butler, Deputy Director Community Development

GENERAL INFORMATION:

Applicant Abdul Alkhafaji

Variance Type **Dimensional Variance**

Property Characteristics

Zoning District:	Residential Acreage
Location:	East of Meadowbrook Road and North of Eight Mile Road
Parcel #:	50-22-36-352-004

Request

The applicant is requesting variances from The City of Novi Zoning Ordinance Section 3.1.1 for a proposed rear yard setback of 46.7 feet (50 feet required, variance of 3.3 feet); and an aggregate total side yard setback of 45.6 feet (50 feet required, variance of 4.4 feet). These variances This variance would accommodate the re-building of a home and a new addition. This property is zoned Residential Acreage (RA). Builder submitted new plans on 4-22-21 that meet the aggregate side yard setback requirement of 50 feet, they have rescinded that portion of the zoning request.

II. STAFF COMMENTS:

III. RECOMMENDATION:

The Zoning Board of Appeals may take one of the following actions:

- 1. I move that we grant the variance in Case No. PZ21-0024, sought by for _____ because Petitioner has shown practical difficulty requiring _____
 - (a) Without the variance Petitioner will be unreasonably prevented or limited with respect to use of the property because_____

(b) The property is unique because

(c) Petitioner did not create the condition because
(d) The relief granted will not unreasonably interfere with adjacent or surrounding properties because
(e) The relief if consistent with the spirit and intent of the ordinance because
(f) The variance granted is subject to:
1
2
3
4
2. I move that we <u>deny</u> the variance in Case No. PZ21-0024 , sought by
for because Petitioner has not shown
practical difficulty requiring
(a) The circumstances and features of the property including are not unique because they
exist generally throughout the City.
(b) The circumstances and features of the property relating to the variance request are self-created because
(c) The failure to grant relief will result in mere inconvenience or inability to attain higher economic or financial return based on Petitioners statements that
(d) The variance would result in interference with the adjacent and surrounding properties by
(e) Granting the variance would be inconsistent with the spirit and intent of the ordinance to
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Should you have any further questions with regards to the matter please feel free to contact me at (248) 347-0417.

Larry Butler Deputy Director Community Development



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LONING BOARD OF APPEALS

APPLICATION

APPLICATION MUST BE FILLED OUT COMPLETELY

RECEIVED

APR 0 8 2021

CITY OF NOVI COMMUNITY DEVELOPMENT

I. PROPERTY INFORMATION (Add	ress of subject ZBA C	ase)	Application Fee:	200.00
PROJECT NAME / SUBDIVISION Medowbrook Manor		//		
41321 Llewelyn Dr, , Northvill	le, 48167		Aeeting Date: <u>M</u>	0
SIDWELL # 352 _ 004	May be o	btain from Assessing ent (248) 347-0485	BA Case #: PZ_2	1-0024
CHESSEYIES OF PROPERTY				
	OCIATION JURISDICTION?	REQUEST IS FOR:		
YES NO				OPERTY LI SIGNAGE
DOES YOUR APPEAL RESULT FROM A NOT II. APPLICANT INFORMATION	ICE OF VIOLATION OR (CITATION ISSUED?		
	EMAIL ADDRESS ahadi2138@gn		CELL PHONE NO 313-414-5800	·····································
	anadi2138@gn	nall.com		
Abdul Ameer Alkhafaji			TELEPHONE NO.	
ORGANIZATION/COMPANY			FAX NO.	
2109 Raven Hill Dr,		Sterling Heights	STATE	ZIP CODE 48318
B. PROPERTY OWNER	RE IF APPLICANT IS ALSO	THE PROPERTY OWNER		
Identify the person or organization that owns the subject property:	EMAIL ADDRESS		CELL PHONE NO.	
NAME			TELEPHONE NO.	
ORGANIZATION/COMPANY			FAX NO.	
ADDRESS		CITY	STATE	ZIP CODE
III. ZONING INFORMATION				
A. ZONING DISTRICT				
☑ R-A □ R-1 □ R-2	\square R-3 \square R-4		_ MH	
B. VARIANCE REQUESTED				
INDICATE ORDINANCE SECTION (S) AND	VARIANCE REQUESTED:			
3.1.1.E	ariance requested	Rear and side setbac	ck/3.5 ft of existin	g newer
2. SectionVariance requested				
3. SectionV	ariance requested			
4. SectionV	ariance requested			
IV. FEES AND DRAWNINGS				
A. FEES				
□ Single Family Residential (Existing) \$200 🗹 (With Violation) \$250 □ Single Family Residential (New) \$250				
□ Multiple/Commercial/Industrial \$300 □ (With Violation) \$400 □ Signs \$300 □ (With Violation) \$400				
□ House Moves \$300 □ Special Meetings (At discretion of Board) \$600				
B. DRAWINGS 1-COPY & 1 DIGITAL COPY SUBMITTED AS A PDF				
 Dimensioned Drawings and Plans Site/Plot Plan Existing & proposed distance to adjacent property lines Location of existing & proposed signs, if applicable 				
 Existing or proposed buildings or addition on the property Floor plans & elevations 				
Number & location of all on-site parking, if applicable Any other information relevant to the Variance application				



ZONING BOARD OF APPEALS APPLICATION

V. VARIANCE A. VARIANCE (S) REQUESTED

DIMENSIONAL USE SIGN

There is a five-(5) hold period before work/action can be taken on variance approvals.

B. SIGN CASES (ONLY)

Your signature on this application indicates that you agree to install a **Mock-Up Sign** ten-(10) days before the schedule ZBA meeting. Failure to install a mock-up sign may result in your case not being heard by the Board, postponed to the next schedule ZBA meeting, or cancelled. A mock-up sign is **NOT** to be actual sign. Upon approval, the mock-up sign must be removed within five-(5) days of the meeting. If the case is denied, the applicant is responsible for all costs involved in the removal of the mock-up or actual sign (if erected under violation) within five-(5) days of the meeting.

C. ORDINANCE

City of Novi Ordinance, Section 3107 – Miscellaneous

No order of the Board permitting the erection of a building shall be valid for a period longer than one-(1) year, unless a building permit for such erection or alteration is obtained within such period and such erection or alteration is started and proceeds to completion in accordance with the terms of such permit.

No order of the Board permitting a use of a building or premises shall be valid for a period longer than one-hundred and eighty-(180) days unless such use is establish within such a period; provided, however, where such use permitted is dependent upon the erection or alteration or a building such order shall continue in force and effect if a building permit for such erection or alteration is obtained within one-(1) year and such erection or alteration is started and proceeds to completion in accordance with the terms of such permit.

D. APPEAL THE DETERMINATION OF THE BUILDING OFFICIAL

PLEASE TAKE NOTICE:

The undersigned hereby appeals the determination of the Building Official / Inspector or Ordinance made

CONSTRUCT NEW HOME/BUILDING ADDITION TO EXISTING HOME/BUILDING SIGNAGE

ACCESSORY BUILDING	🗆 USE
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JSE	

VI. APPLICANT & PROPERTY SIGNATURES	
A. APPLICANT Applicant Signature	<u> </u>
B. PROPERTY OWNER	
If the applicant is not the owner, the property owner must re	ead and sign below:
The undersigned affirms and acknowledges that he, she or they a	-
application, and is/are aware of the contents of this application of	and related enclosures.
Property Owner Signature	Date
	and strength and the property of the Winter Strength and the strength of the strength of the strength of the st
VII. FOR OFFICIAL USE ONLY	
DECISION ON APPEAL:	
GRANTED	
The Building Inspector is hereby directed to issue a permit to the A	pplicant upon the following and conditions:

Chairperson, Zoning Board of Appeals

Date

FAX NO. :



Community Development Department 45175 Ten Mile Road Novi, MI 48375 (248) 347-0415 Phone (248) 735-5600 Facsimile www.cityofnovi.org

REVIEW STANDARDS DIMENSIONAL VARIANCE

The Zoning Board of Appeals (ZBA) will review the application package and determine if the proposed Dimensional Variance meets the required standards for approval. In the space below, and on additional paper if necessary, explain how the proposed project meets each of the following standards. (Increased costs associated with complying with the Zoning Ordinance will not be considered a basis for granting a Dimensional Variance.)

Standard #1. Circumstances or Physical Conditions.

Explain the circumstances or physical conditions that apply to the property that do not apply generally to other properties in the same zoning district or in the general vicinity. Circumstances or physical conditions may include:

a. Shape of Lot. Exceptional narrowness, shallowness or shape of a specific property in existence on the effective date of the Zoning Ordinance or amendment.
 Not Applicable
 Applicable
 If applicable, describe below:

and/or

and/or

Abutting Property. The use or development of the property immediately adjacent to the subject property would prohibit the literal enforcement of the requirements of the Zoning Ordinance or would involve significant practical difficulties.
 Not Applicable Applicable If applicable, describe below;


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Building 113 ZBA Raview Standards Dimensional Revised 06/15



(myth Umstill	PROJECT: PLOT PLAN
	LOCATION: 41321 LLEWELYN DR NORTHVILLE, MI 48167
	<u>APPLICANT:</u>
	\square
CEL NUMBER: 50-22-36-352-004 <u>AL DESCRIPTION:</u> R8E, SEC 36 MEADOWBROOK MANOR NO 1 LOT 18	F&M ENGINEERING
PROPERTY LINE Image: Constraint of the	PLLC 12703 PATTON ST. DEARBORN, MI 48126 PH:(313) 978-1621 PH:(313) 978-1621 EM:BAZNAFR@GMAIL.COM
POWER POLE / LIGHT POLE WATER SHOT-OFF FIRE HYDRANT →→→→→→→→→→→→→→→→→→→→→→→→→→→→→→→→→→→→	<u>DRAWN BY:</u> M. A.
EXISTING GRADES 2003 PROPOSED GRADES 070.3 DRAINAGE DIRECTION	APPROVED BY: MOHAMED BAZNA
COMPLIANCE:	
R-A (RESIDENTIAL ACREAGE) 38,834 SQ.FT. = 0.891 ACRES A OF RESIDENTIAL = 6,365 SQ.FT.	SUBMITTALS
2-CAR GARAGE #1= 489 SQ.FT. 2-CAR GARAGE #2= 618 SQ.FT. 3ALCONY= 76 SQ.FT. <u>COVERED PATIO= 780 SQ.FT.</u> _ AREA OF ALL STRUCTURES= 8,328 SQ.FT.	REVISIONS:
HEIGHT: REQUIRED: 35 FT. PROPOSED: 22'-6" TO MIDPOINT OF ROOF RAGE: REQUIRED: 25%	03/18/2021
PROPOSED: 8,328/38,813= 21.45% OK	PROJECT NO
HEIGHT: REQUIRED: 35 FT. PROPOSED: 22'-6" TO MIDPOINT OF ROOF RAGE: REQUIRED: 25% PROPOSED: 8,328/38,813= 21.45% OK MOHAMED * MOHAMED * MOHAMED * MOHAMED * MOHAMED NASRI BAZNA Ho * OF BAZNA Ho OF No. 32351 OF OF OFESSION OF OF OF	DATE 03/13/2021 SCALE NOTED SHEET TITLE PLOT PLAN
δ_{c} No. 32351 δ_{c}	1 OF 1

PBR21-0123

PBRZI-0123

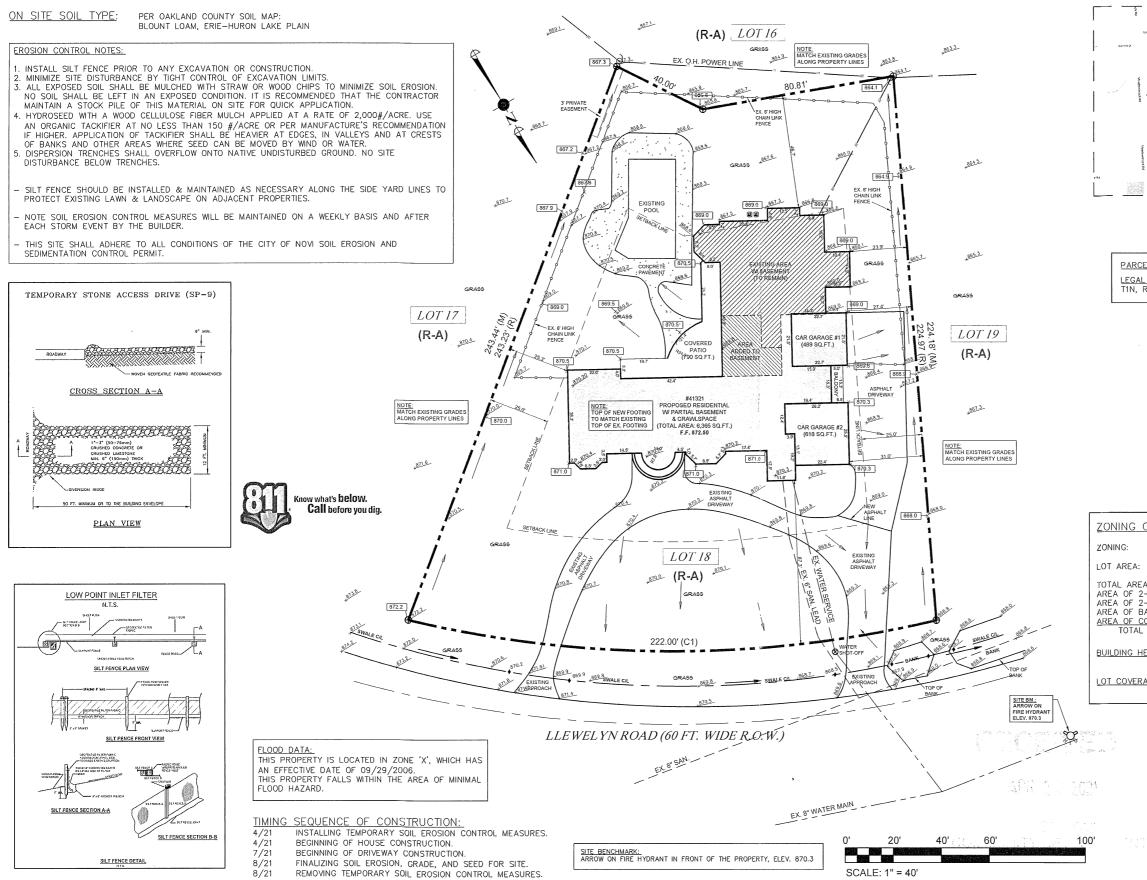RECEIVED APR 2 2 2021 CITY OF NOVI COMMUNITY DEVELOPMENT

Malidada

PROJECT: RESIDENTIAL ADDITION ADDRESS:

41321 LLEWELYN DR. NORTHVILLE, MI 48167

SWALE C/L

DRAWING INDEX SHEET NO. | SHEET TITLE ARCHITECTURAL SITE PLAN (COVER SHEET) A-1 A-2 EXISTING / DEMO PLAN PROPOSED FOUNDATION PLAN A-3 A-4 PROPOSED FLOOR PLAN PROPOSED ROOF & TYPICAL WALL SECTION A-5 PROPOSED FRONT & RIGHT ELEVATIONS A-6 PROPOSED REAR & LEFT ELEVATIONS A-7 P-1 ROUGH-IN PLUMBING PLANS ELECTRICAL PLANS

* GENERAL CONTRACTOR TO MAINTAIN AT THE PROJECT SITE ONE COPY OF THE CITY APPROVED PLANS

Burner Burner 1 Burner Burner Car

ALL CONSTRUCTION TO COMPLY WITH M.R.C. 2015, LOCAL CODES AND COMPLIANCE. 2015 MICHIGAN UNIFORM ENERGY CODE ALL MANUFACTURED MATERIALS TO BE HANDLED AND INSTALLED PER MANUFACTURERS INSTRUCTIONS AND REQUIREMENTS UNLESS OTHERWISE NOTED BY THESE DOCUMENTS SOIL BEARING CAPACITY TO BE 2,500 P.S.F.

UNLESS NOTED OTHERWISE (U.N.O.) DIMENSIONS ARE FROM FINISH TO FINISH FACE. NOMINAL THICKNESS DIMENSIONS ARE USED FOR MASONRY INTERIOR PARTITIONS THICKNESS TO BE 4 1/2" (U.N.O.).

CONCRETE SHALL BE 3,000 P.S.I. AT 28 DAY TESTING

ALL STRUCTURAL STEEL SHALL CONFORM TO THE REQUIREMENTS OF ASTM A-36.

ALL CONCRETE BLOCKS TO BE TYPE N-1, MORTAR SHALL BE TYPE "S". ALL BRICK SHALL BE SW GRADE, ASTM C-216 TYPE FBS, MORTAR SHALL BE TYPE "N". METAL TYPE FOR BRICK VENEER SHALL BE CORROSION RESISTANT METAL OR GALVANIZED AND SHALL BE PLACED 16" O.C. EACH WAY.

WOOD FRAMING TO BE DONE IN ACCORDANCE TO NATIONAL LUMBER MANUFACTURERS ASSOCIATION RECOMMENDED PRACTICE FOR WOOD FRAMING.

ALL STRUCTURAL LUMBER: JOIST AND HEADERS TO BE MIN. FU250, FU REPETITIVE 1450 UNLESS OTHERWISE NOTED. MIN. E=1,600,000. ALL STUDS TO BE STUD GRADE OR BETTER, FC MIN. 425.

MICRO-LAM BEAM SHALL HAVE AN F6=2,800 P.S.I. AS MANUF. BY "TRUSS JOIST CORP." OR EQUAL AND SHALL BE FASTENED TOGETHER PER MANUF. SPECIFICATIONS.

ALL FLUSH FRAMING CONNECTIONS, JOIST AND BEAM HANGERS, POST CAPS, FRAMING AND RAFTER ANCHORS TO BE SIMPSON STRONG TIE" OR EQUAL.

TRUSS DESIGN, INSTALLATION AND BRACING SHALL BE PER TRUSS MANUFACTURER SHOP DRAWINGS AND SPECIFICATIONS. PROVIDE CONTINUOUS ROWS OF BRIDGING AT FLOOR JOIST @ 8'-0" O.C. MAX.

ALL SILL PLATES SHALL BE SECURED WITH ANCHOR BOLTS OR METAL ANCHOR STRAPS SET INTO CONC. @ 6'-0" O.C. MAX. OR PER MANUF. SPECIFICATIONS.

ALL BUILT-UP WOOD POSTS CONSISTING OF (2)2X4'S OR GREATER TO BE GLUED AND SPIKED TOGETHER.

DOUBLE FLOOR JOIST UNDER ALL PARALLEL PARTITIONS.

PROVIDE SCREENED ROOF VENTILATION @ 1/300 OF THE TOTAL ENCLOSED AREA WITH 50% OF THE REQUIRED AREA IN THE UPPER ½ OF THE ROOF AND 50% IN THE EAVE/CORNICE SECTION OF THE ROOF.

PROVIDE A 22"X30" ATTIC ACCESS TO ALL ATTIC AREAS HAVING A CLEAR HEIGHT OF OVER 30".

PROVIDE GROUND FAULT INTERRUPTERS AT ALL INTERIOR OUTLETS ADJACENT TO WATER SOURCES AS WELL AS ALL OTHER LOCATIONS REQUIRED BY CODE. EXTERIOR OUTLETS TO BE WATERPROOF.

SMOKE DETECTORS TO BE INSTALLED IN ALL LIVING UNITS IN ACCORDANCE WITH N.E.C. AND LOCAL BUILDING AUTHORITY, TO BE WIRED AND INTERCONNECTED WITH BATTERY BACK-UP.

CARBON MONOXIDE ALARM SHALL BE INSTALLED IN ACCORDANCE WITH R315. ALARM SHALL BE INSTALLED OUTSIDE OF EACH SEPARATE SLEEPING AREA IN THE IMMEDIATE VICINITY OF THE BEDROOMS. ALARM SHALL BE LISTED AS COMPLYING WITH UL 2034 AND SHALL BE INSTALLED IN ACCORDANCE WITH R315 AND THE MANUFACTURER INSTALLATION INSTRUCTIONS.

ALL GLAZING 18" OR LESS A.F.F. TO BE TEMPERED GLASS AS WELL AS ALL OTHERS SPECIFIED BY M.R.C. SECTION R308,4 OR LATEST EDITION, LOCATIONS TO BE VERIFIED BY WINDOW MANUFACTURER. WINDOWS IN SLEEPING AREAS TO MEET M.R.C. REQUIREMENTS FOR EGRESS PER SECTION R310 OR LATEST EDITION, WINDOW

MANUFACTURER TO VERIFY. EXHAUST FANS TO BE VENTED DIRECTLY OUTSIDE.

DESIGN LOADS: (P.S.F.)	GENERAL LIVING	BEDROOM	ROOF
LIVE LOAD	40	30	25(TOP CHORD) 10(BOTTOM CHORD)
DEAD LOAD	15(25 W/TILE)	15	7(TOP CHORD) 5(BOTTOM CHORD)
TOTAL	55(65 W/TILE)	45	47

ALL NOTCHES AND HOLES BORED OR CUT INTO JOISTS, RAFTERS OR BEAMS SHALL COMPLY WITH M.R.C. SECTIONS R502.8, R602.6, P2603.2. NOTCHES SHALL NOT EXCEED ONE-SIXTH OF THE DEPTH OF THE MEMBER, SHALL NOT BE LONGER THAN ONE-THIRD OF THE DEPTH OF THE MEMBER AND SHALL NOT BE LOCATED IN THE MIDDLE ONE-THIRD OF THE SPAN. NOTCH DEPTH AT THE ENDS OF THE MEMBER SHALL NOT EXCEED ONE-FOURTH OF THE DEPTH OF THE MEMBER. HOLES SHALL NOT BE CLOSER THAN 2" TO THE TOP OR THE BOTTOM OF THE JOIST OR TO ANY OTHER HOLE OR NOTCH LOCATED IN THE MEMBER. THE DIAMETER OF THE HOLE IN THE JOIST SHALL NOT EXCEED ONE-THIRD OF THE DEPTH OF THE MEMBER.


DOOR HARDWARE: DOOR HANDLES, PULLS, LATCHES, LOCKS AND OTHER OPERATING DEVICES SHALL BE AT A MAXIMUM HEIGHT OF 48" A.F.F.

DRAFTSTOPPING SHALL COMPLY WITH M.R.C. SECTION 302.12. DRAFTSTOPPING MATERIAL SHALL NOT BE LESS THAN $\frac{1}{2}$ GYPSUM BOARD, 3/1" PLYWOOD OR OTHER APPROVED MATERIALS ADEQUATELY SUPPORTED. FIRESTOPPING AND DRAFTSTOPPING SHALL NOT BE CONCEALED FROM VIEW UNTIL INSPECTED AND APPROVED.

FLASHING SHALL COMPLY WITH M.R.C. SECTION 703.7.5, 703.8.



- ENERGY COMPLIANCE REPORT - ENERGY CODE 2009

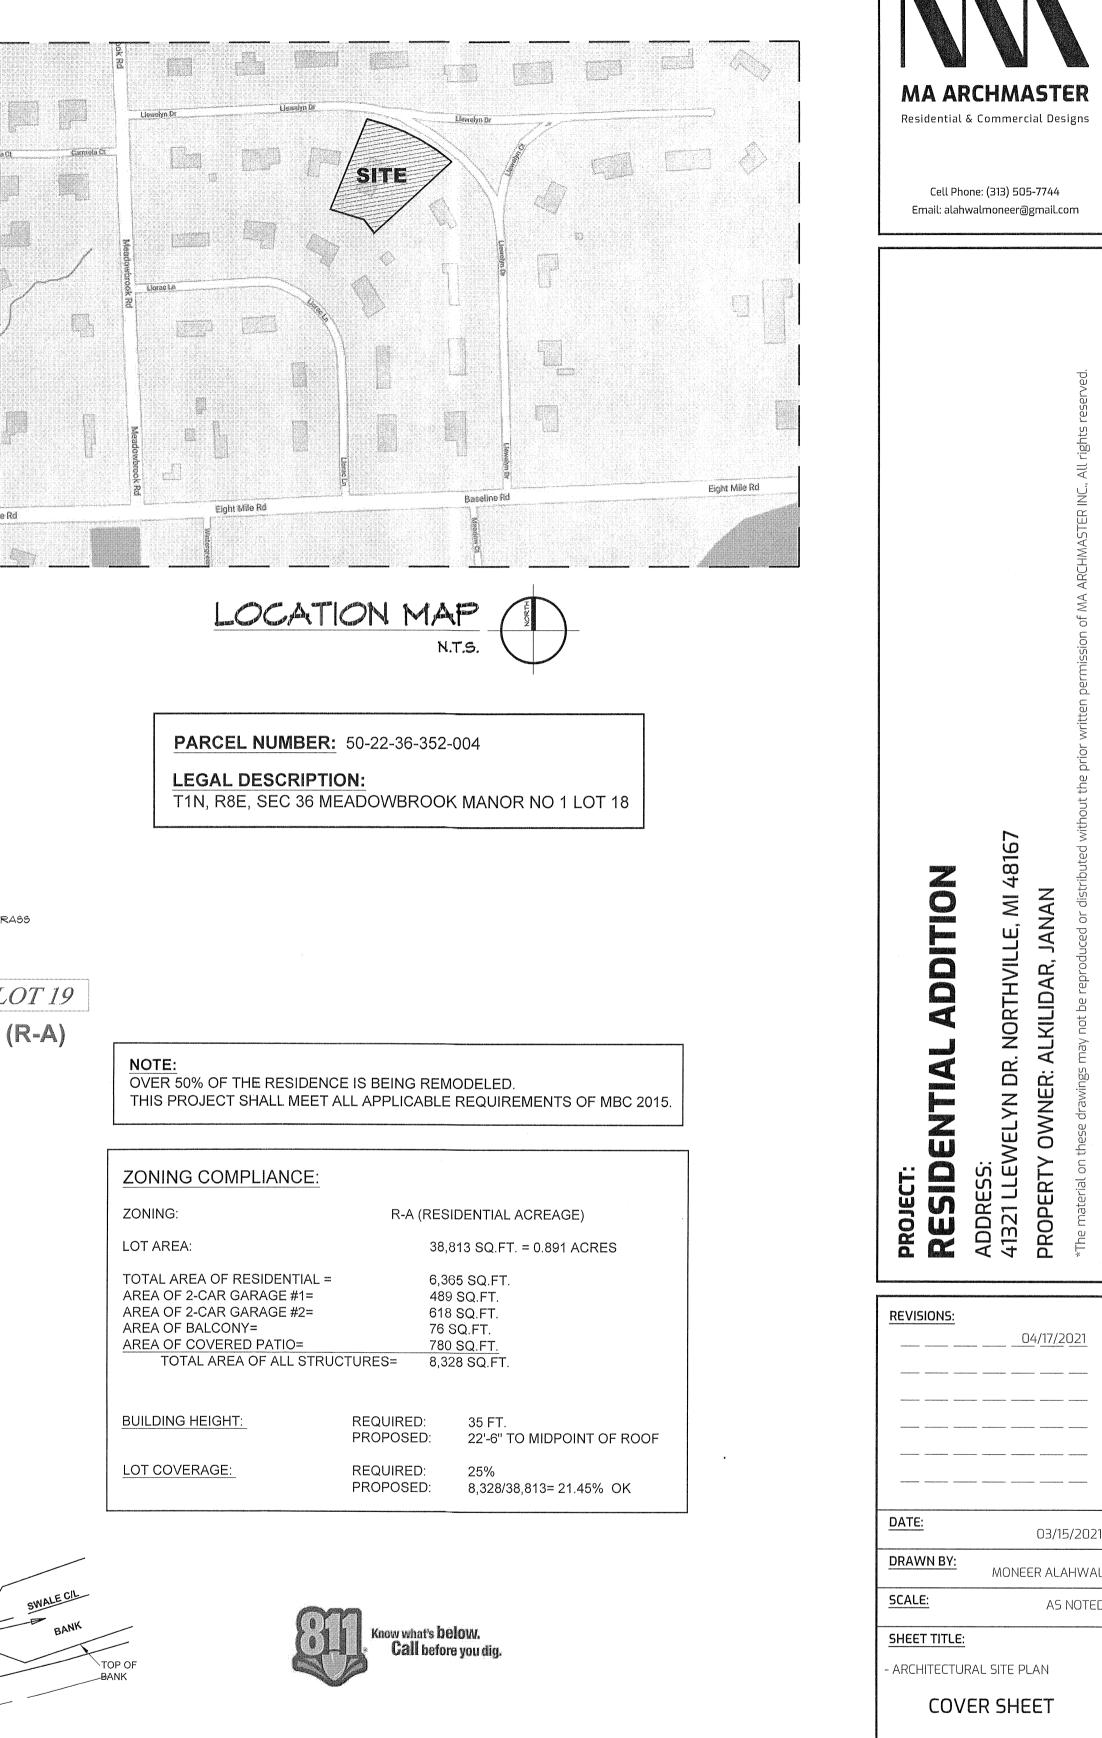


SHEET #:

APPROVED BY:

A-1

TAHA M. KHALAFF ENGINEER No. 63348

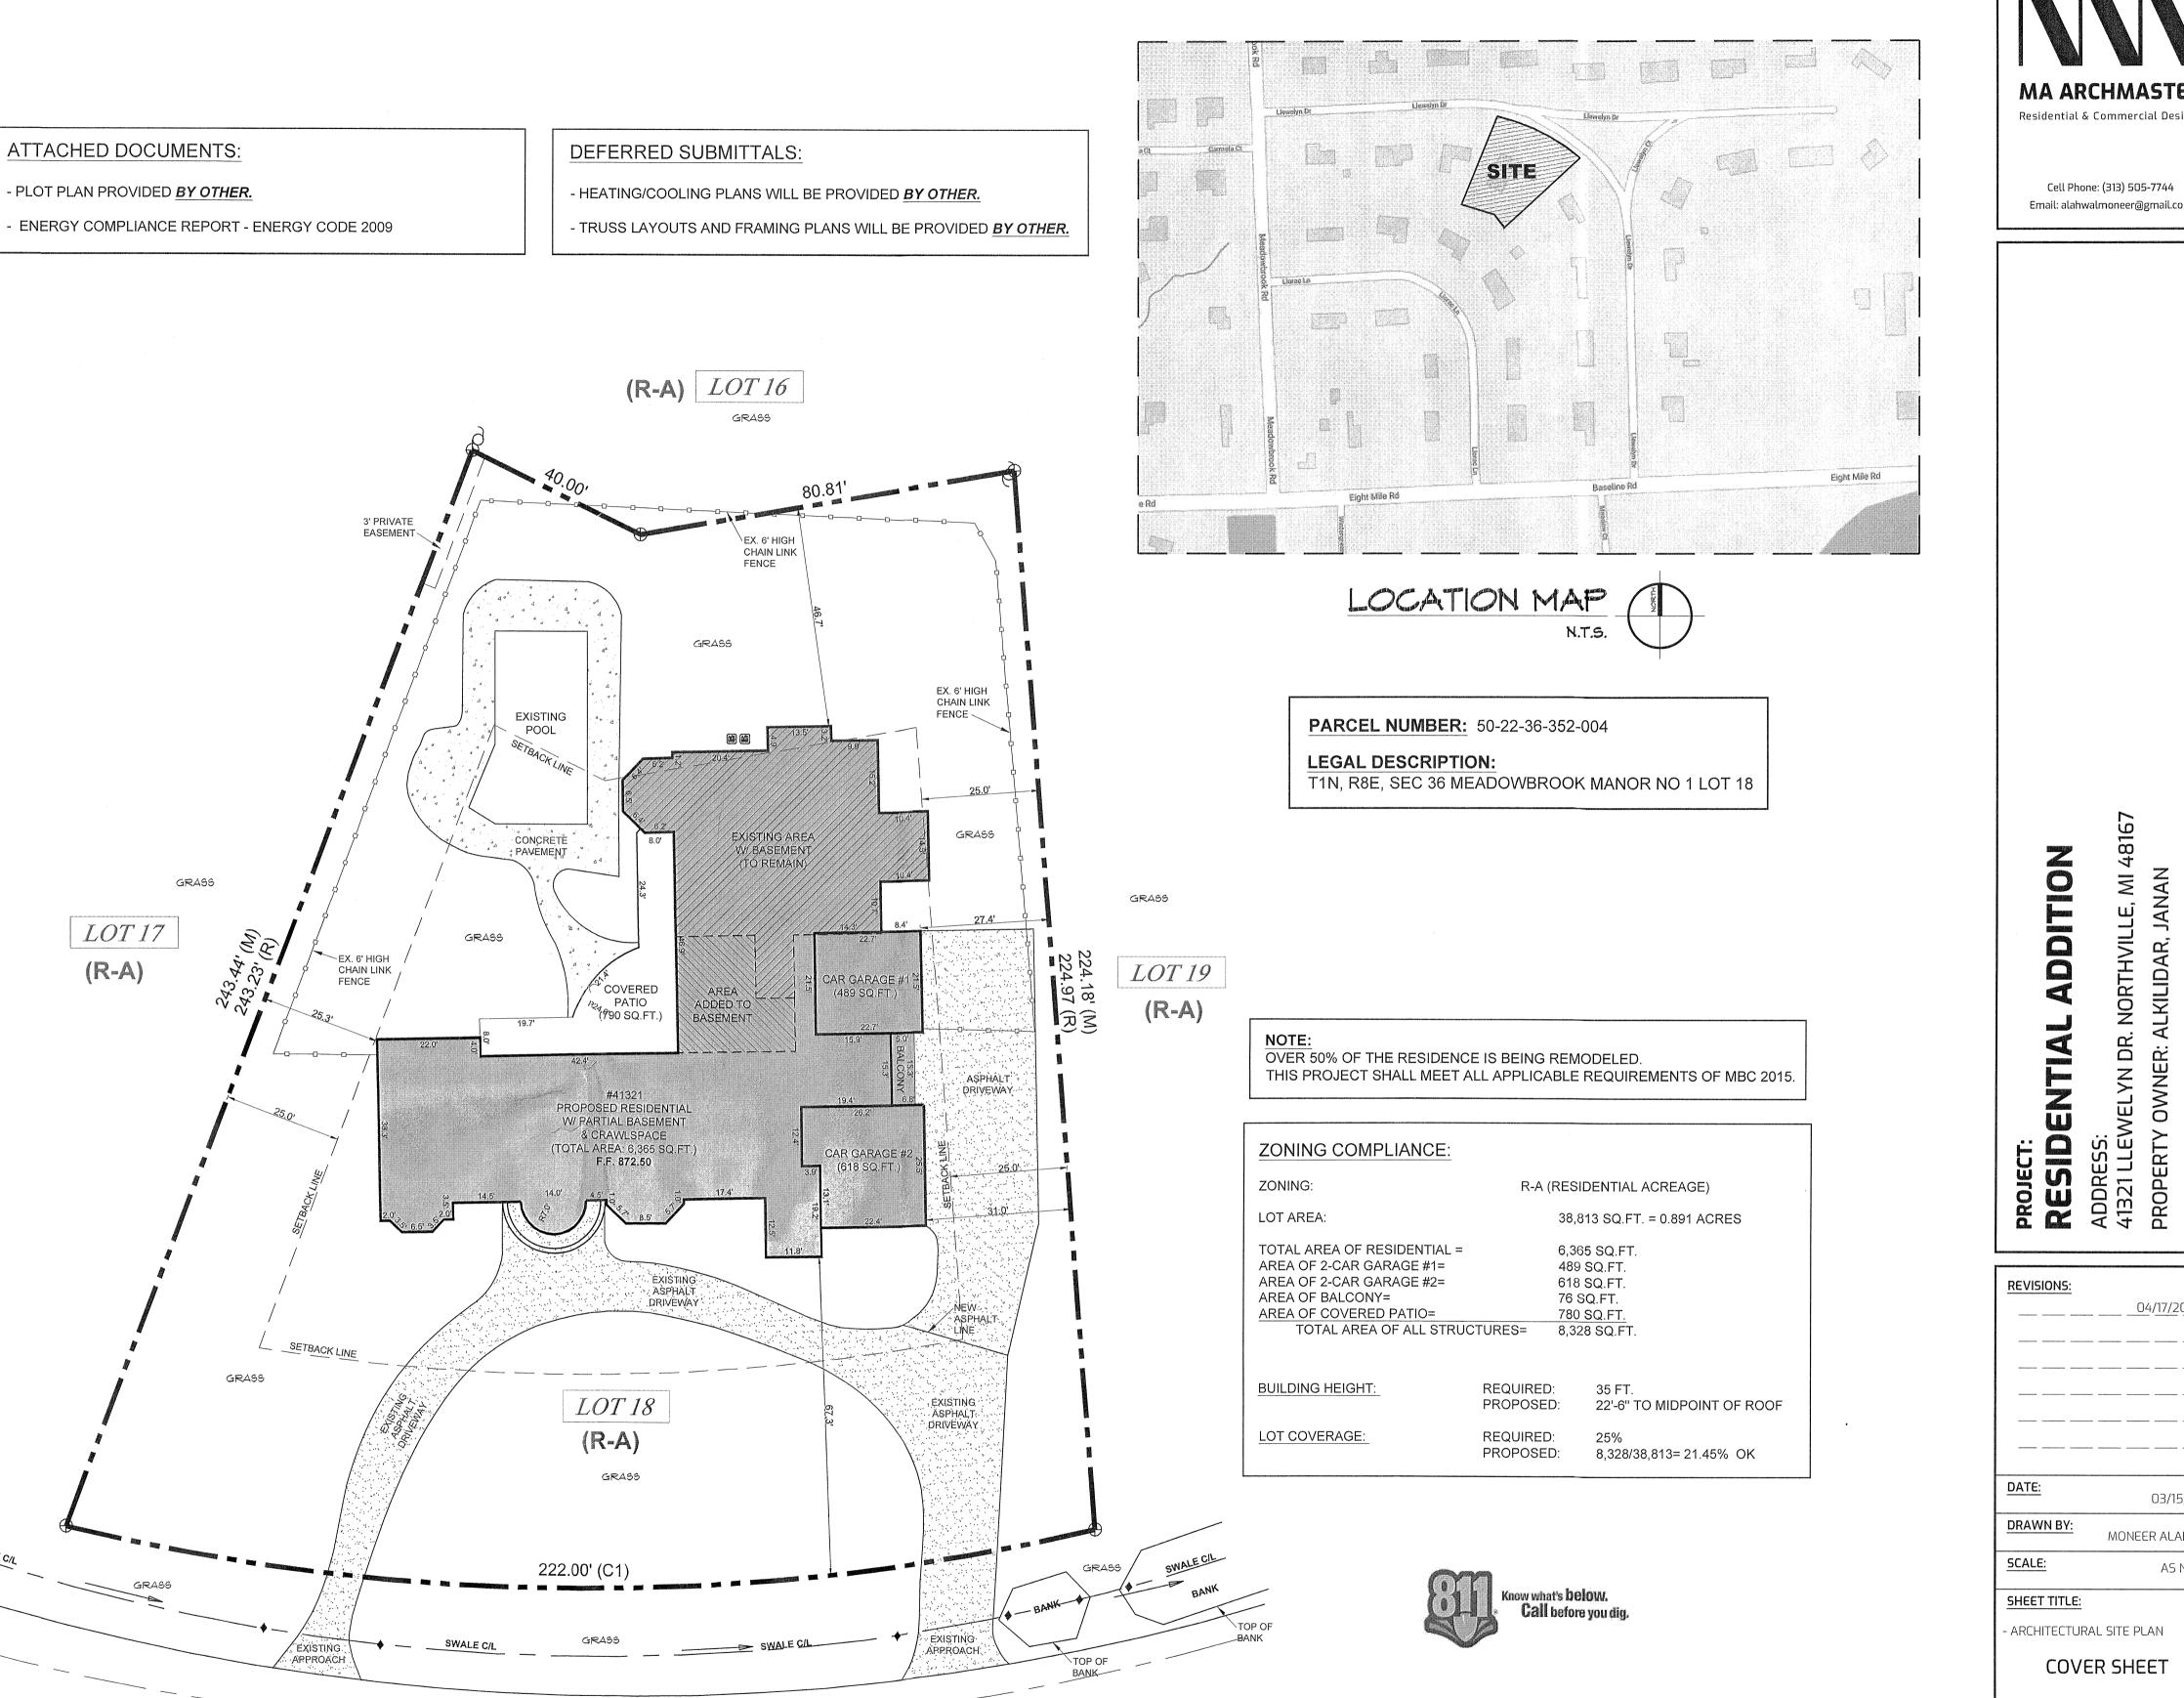

LLEWELYN ROAD (60 FT. WIDE R.O.W.)

ARCHITECTURAL SITE PLAN SCALE: 1" = 10'-0"

GENERAL NOTES

GENERAL CONDITIONS:

I. TEMPORARY BRACING, GUYING AND TIEDOWNS OF THE STRUCTURE DURING ERECTION SHALL BE THE RESPONSIBILITY OF THE ERECTOR AND CONTRACTOR. THE ENGINEER AND ARCHITECT ASSUME NO RESPONSIBILITY FOR THE ABSENCE, PRESENCE OR ADEQUACY OF ANY TEMPORARY BRACING. ALL EXISTING STRUCTURES THAT MAY BE AFFECTED BY THE NEW CONSTRUCTION SHALL BE BRACED AND PROTECTED AS REQUIRED.

 2. THE STRUCTURAL DRAWINGS ARE FOR THE PLACEMENT AND SIZE OF STRUCTURAL COMPONENTS ONLY. O.S.H.A., MI.O.S.H.A., D.N.R. AND SAFETY CODE REQUIREMENTS ARE DETERMINED AND PROVIDED BY OTHERS.
 3. IF ANY GENERAL NOTE CONFLICTS WITH ANY DETAIL OR NOTE ON THE PLANS OR IN THE SPECIFICATIONS, THE STRICTEST PROVISION SHALL GOVERN.

EXISTING CONDITIONS:

I. VERIFY ALL EXISTING ASSUMED DIMENSIONS AND CONDITIONS (I.E. EXISTING MATERIALS & FRAMING MEMBER SIZES AND LOCATIONS & METHODS OF CONSTRUCTION & ETC.) IN FIELD PRIOR TO CONSTRUCTION. IF DISCREPANCIES ARE FOUND, NOTIFY ARCHITECT BEFORE PROCEEDING WITH WORK. FOUNDATIONS

I. FOOTINGS SHALL BEAR ON FIRM UNDISTURBED SOIL WITH A SAFE BEARING CAPACITY OF 3,000 P.S.F. IF SOIL OF THIS CAPACITY IS NOT FOUND AT THE ELEVATIONS INDICATED, FOOTINGS SHALL BE ENLARGED OR LOWERED AT THE DIRECTION OF THE ARCHITECT. VERIFY FOUNDATION SOIL BEARING PRESSURE IN FIELD BY SOILS LAB. 2. WHERE NEW FOOTINGS ABUT EXISTING FOUNDATIONS, CAREFULLY HAND

EXCAVATE AND PLACE BOTTOM OF NEW FOOTING AT THE SAME ELEVATION AS THE EXISTING FOUNDATIONS.

CONCRETE:

I. MINIMUM CONCRETE STRENGTH TO BE 3000 P.S.I. @ 28 DAYS, SLABS SHALL BE 3500 P.S.I. MIN. U.O. N. ± W/ & + 1% ENTRAINED AIR WHERE EXPOSED TO WEATHER. 2. ALL CONCRETE WORK AND PLACEMENT SHALL CONFORM TO THE LATEST RECOMMENDATIONS OF A.C.I.

3. ALL REINFORCING BARS, DOWELS AND TIES SHALL CONFORM TO A.S.T.M. AGI5 GRADE 60. REINFORCING STEEL SHALL BE CONTINUOUS AND SHALL HAVE MINIMUM 36 BAR DIAMETER LAP AND BE FABRICATED AND PLACED IN ACCORDANCE A.C.I. 4. REINFORCED CONCRETE WALLS AND TRENCH FOOTINGS SHALL HAVE CORNER BARS AT ALL INTERSECTIONS OF THE SAME SIZE AND SPACING AS THE MAIN HORIZONTAL REINFORCING. PROVIDE 2-#5 × 4'-0' DIAGONAL BARS AT CORNERS OF OPENINGS. 5. DO NOT BACK-FILL AGAINST BASEMENT WALLS UNTIL FIRST FLOOR AND SLABS ARE IN PLACE OR WALLS ARE ADEQUATELY LATERALLY BRACED.

MASONRY:

I. ALL MAGONRY WORK IS TO BE IN ACCORDANCE WITH THE LATEST A.C.I. AND N.C.M.A. SPECIFICATIONS.

ALL BLOCK MASONRY SHALL CONFORM TO ASTM C90 OR CI45 TYPE N-1, MORTAR IS
 TO BE TYPE 'S'.
 PROVIDE HORIZONTAL WIRE TYPE REINFORCING WITH 9 GAUGE SIDE AND CROSS

MEMBERS IN EVERY SECOND COURSE (16" O.C.), IN ALL MASONRY WALLS. WALLS WITH VERTICAL REINFORCING SHALL ONLY HAVE "LADDER" TYPE REINFORCING. 4. PROVIDE CONTINUOUS MASONRY BOND BEAMS AT PERIMETER OF ALL VERTICAL MASONRY SHAFTS AT EACH FLOOR WITH A MINIMUM OF 2-#4 CONTINUOUS BARS GROUTED SOLID.

5. ALL MASONRY BEARING STEEL BEAMS AND LINTELS TO BEAR 8' MINIMUM ON 3 COURSES SOLID MASONRY, WITH 2-3/4" DIAMETER BOLTS EACH END, UNLESS OTHERWISE NOTED.

6. UNLESS OTHERWISE NOTED, PROVIDE L 4 X 3-1/2 X 5/16 L.L.V. LINTEL FOR EACH 4" OF MASONRY FOR SPANS UP TO 5'-Ø" MAX. 7. ALL DOUBLE ANGLE LINTELS SHALL BE WELDED BACK TO BACK WITH A MINIMUM 2 INCH STITCH WELD EVERY & INCHES.

STRUCTURAL WOOD FRAMING NOTES:

I. WOOD CONSTRUCTION SHALL BE PER AMERICAN INSTITUTE OF TIMBER CONSTRUCTION (AITC) AND NATIONAL FOREST PRODUCTS ASSOCIATION (NFPA) STANDARDS AND SPECIFICATIONS

2. OWNER/CONTRACTOR OR LUMBER MANUFACTURER/SUPLIER SHALL PROVIDE SPECIFICATIONS AND SPAN DATA FOR ALL FRAMING MEMBERS BASED ON THE NATIONAL DESIGN SPECIFICATION FOR WOOD CONSTRUCTION (NDS) AS PUBLISHED BY THE NATIONAL FOREST PRODUCTS ASSOCIATION (NFPA).

3. FLITCH PLATED BEAMS SHALL BE COMPRISED OF TWO PIECES OF SOUTHERN PINE NO. 2 OF THE SIZE INDICATED ON THE PLANS, AND AN ASTM A36 STEEL PLATE OF THE THICKNESS INDICATED ON THE PLANS, AND EQUAL IN DEPTH TO THE ACTUAL SIZE OF THE 2 X MEMBER. THE BEAM SHALL BE THROUGH BOLTED WITH ?" DIAMETER BOLTS IN TWO ROWS, STAGGERED AT 16" ON CENTER, WITH TWO BOLTS AT EACH END. 4. PROVIDE I X 4 DIAGONAL BRIDGING OR SOLID BLOCKING AT 4'-@" ON CENTER, MAXIMUM, IN ALL FLOOR JOISTS.

5. PROVIDE DOUBLE JOISTS UNDER ALL NON-BEARING PARTITIONS PARALLEL TO THE SPAN OF THE FLOOR JOISTS. 6. DO NOT CUT FRAMING MEMBERS FOR PLUMBING, ELECTRICAL, OR MECHANICAL

WITHOUT REINFORCING THE MEMBER TO ITS ORIGINAL CAPACITY. 1. LUMBER FOR 2 × 4 AND 2 × 6 STUDS SHALL BE STUD GRADE SPRUCE-PINE-FIR, OR EQUAL, UNLESS NOTED OTHERWISE.

8. STUD WALLS SUPPORTING TWO FLOORS, CEILING. AND ROOF LOADS SHALL BE 2 × 6 AT 16" CENTER TO CENTER! ALL OTHERS SHALL BE 2 × 4 AT 16" CENTER TO CENTER, UNLESS NOTED OTHERWISE. STUD WALLS UP TO 3'-0" TALL TO BE BLOCKED SOLID AT MID=HEIGHT. TALLER WALLS TO BE BLOCKED SOLID AT THIRD POINTS. 9. BALLON FRAME ALL TWO-STORY WALLS WHERE LATERAL FRAMING DOES NOT

PROVIDE MID-HEIGHT BRACING. IF TWO-STORY WALLS HAVE EXCESSIVE OPENINGS, USE VERTICAL STEEL FLITCH PLATES AND 2 × 6 FRAMING. 10. ALL HEADERS AND BEAMS TO BE SUPPORTED BY BUILT-UP 2 × 'S OR COLUMNS AS SHOWN ON THE PLANS. SUPPORT TO BE CONTINUOUS TO FOUNDTION OR OTHER

SHOWN ON THE PLANS, SUPPORT TO BE CONTINUED TO FOUND HOR OR OTHER SUPPORT BELOW. PROVIDE DOUBLE STUD AT EACH END OF WOOD HEADERS, TYPICAL UNLESS NOTED OTHERWISE. II. BEARING TYPE CONNECTIONS MAY BE TOE-NAILED. ALL OTHER CONNECTIONS OF

STRUCTURAL MEMBERS SHALL BE MADE BY USING METAL JOIST HANGERS. 12. ALL KNEE WALL CONSTRUCTION TO BE DIAGONALLY BRACED AT 4'-0" CENTER TO CENTER, MAXIMUM. 13. ALL LUMBER IN CONTACT WITH MASONRY OR CONCRETE TO BE PRESSURE TREATED.

PROVIDE PRESSURE TREATED LUMBER AT ALL OTHER LOCATIONS SHOWN ON THE PLANS.

14. TIMBER SUPPLIER SHALL BE A MEMBER OF AITC. TIMBER CONNECTIONS TO BE DESIGNED AND DETAILED BY TIMBER SUPPLIER, WITH FABRICATION BY STEEL FABRICATOR.


15. TRUSS MANUFACTURER SHALL PROVIDE SHOP DRAWINGS SEALED BY A PROFESSIONAL ENGINEER REGISTERED IN THE STATE OF MICHIGAN. TRUSS MANUFACTURER SHALL VERIFY WITH ARCHITECT AND MECHANICAL CONTRACTOR SIZE, LOCATION & SUPPORT OF MECHANICAL UNITS.
16. TRUSS TOP CHORD MUST BE BRACED WITH ROOF SHEETING OR CONTINUOUS LATERAL BRACING AT 3'-Ø' Ø.C. BOTTOM CHORD MUST BE BRACED WITH A RIGID CEILING OR CONTINUOUS BRACING AT 10'-Ø' O.C. PLYWOOD SHEETING SHALL BE NAILED OR SCREWED TO TRUSS MEMBERS AT 6'' O.C. MAXIMUM SPACING.
17. THE TRUSS MANUFACTURER SHALL PROVIDE INSTALLATION DETAILS FOR ALL TRUSSES, SHOWING TEMPORARY AND PERMENANT BRACING AND BRIDGING LOCATIONS.

18. DESIGN OF THE LUMBER AND CONNECTER PLATES FOR TRUSS SHALL BE IN ACCORDANCE WITH THE LATEST TRUSS PLANE INSTITUTE (TPI) REQUIREMENTS.


DEMOLITION NOTES:


I. ELECTRICAL CONTRACTOR SHALL REMOVE ALL WIRING AND OUTLETS IN EXISTING WALLS THAT ARE TO BE REMOVED.


- 2. PLUMBING CONTRACTOR SHALL CAP ALL EXISTING PLUMBING SUPPLY AND WASTE LINES THAT WILL NOT BE RE-USED.
- 3. PATCH AND REPAIR ALL EXISTING WALL SURFACES THAT ARE TO
- REMAIN AT AREAS WHERE EXISTING CONSTRUCTION IS TO BE REMOVED. 4. GENERAL CONTRACTOR SHALL BE RESPONSIBLE FOR PROPER REMOVAL
- OF ALL DEBRIS AND CONSTRUCTION SPOILS. 5. SHORE & BRACE EXISTING CONSTRUCTION AS REQUIRED DURING DEMOLITION. 6. CONTRACTORS SHALL NOT ENGAGE IN ANY WORK ACTIVITY THAT WILL
- RESULT IN THE PRODUCTION OF ANY NOXIOUS ODORS OR SMOKE WITHOUT THE CONSENT OF THE OWNER. 1. CONTRACTORS SHALL HAVE AN APPROVED FIRE EXTINGUISHER AVAILABLE AT ALL TIMES WHEN OPEN IS AME IS REQUIRED IN THE REPORTANCE
- AT ALL TIMES WHEN OPEN FLAME IS REQUIRED IN THE PERFORMANCE OF THE WORK.

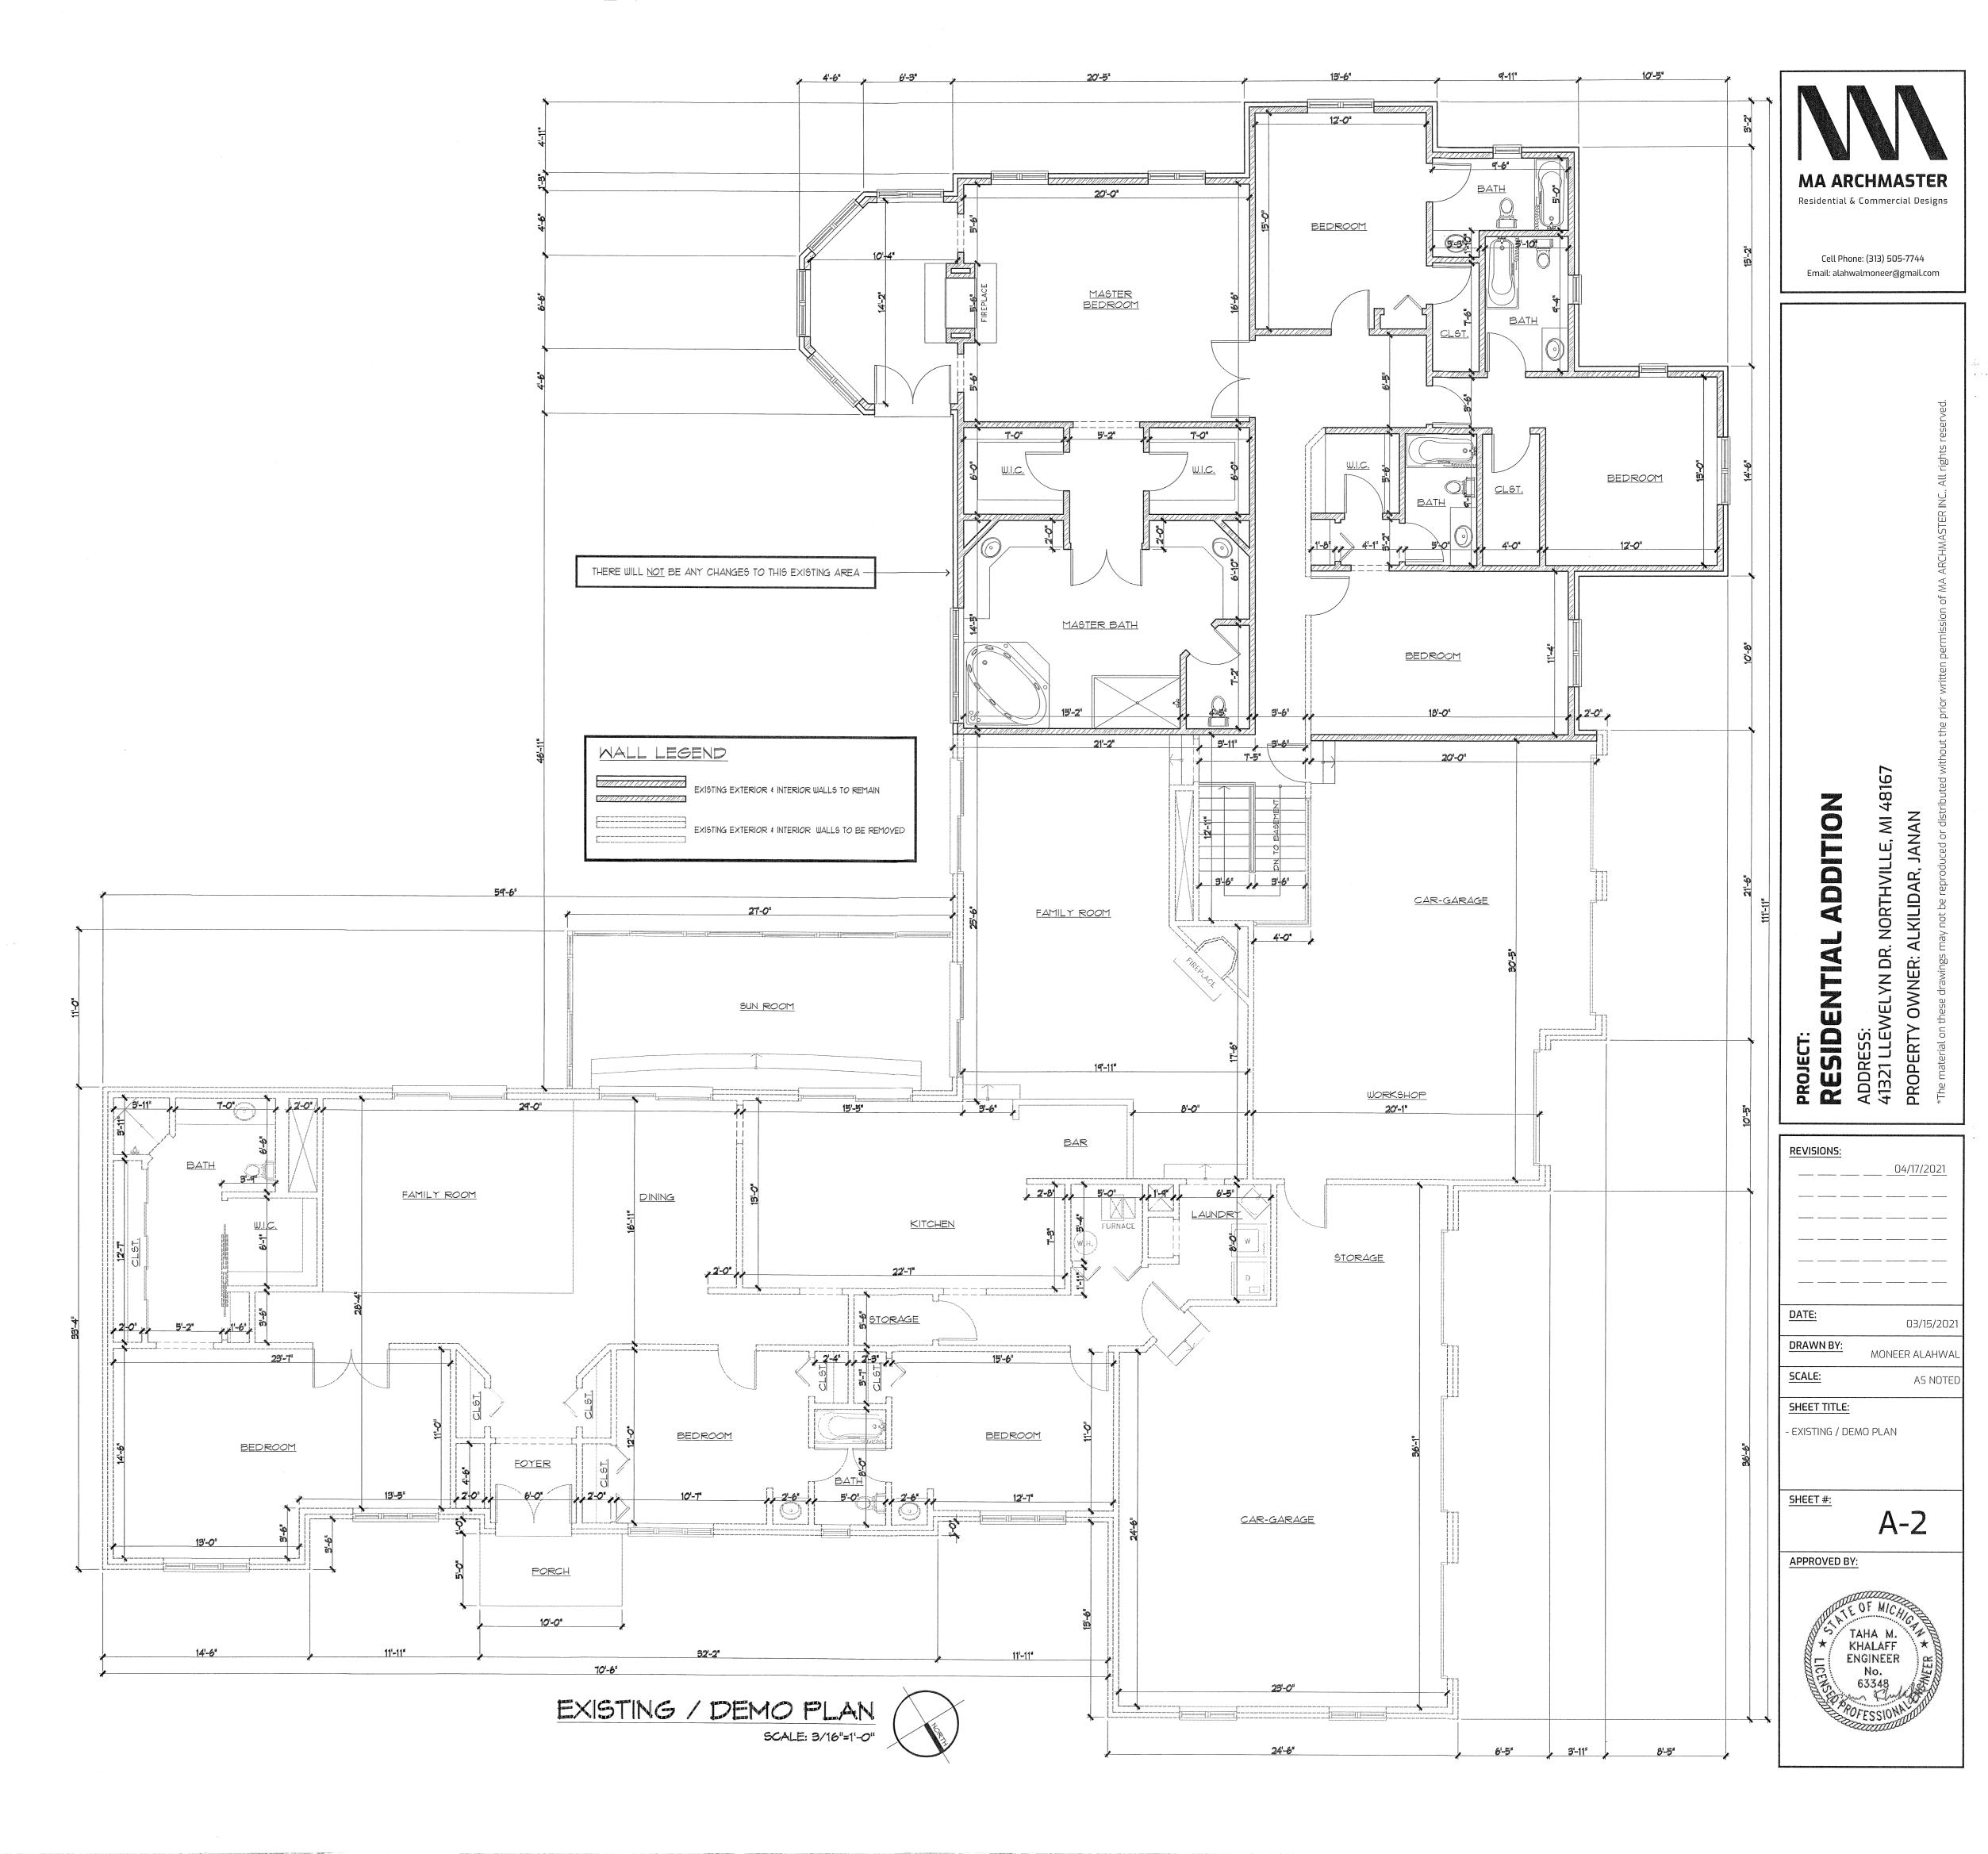



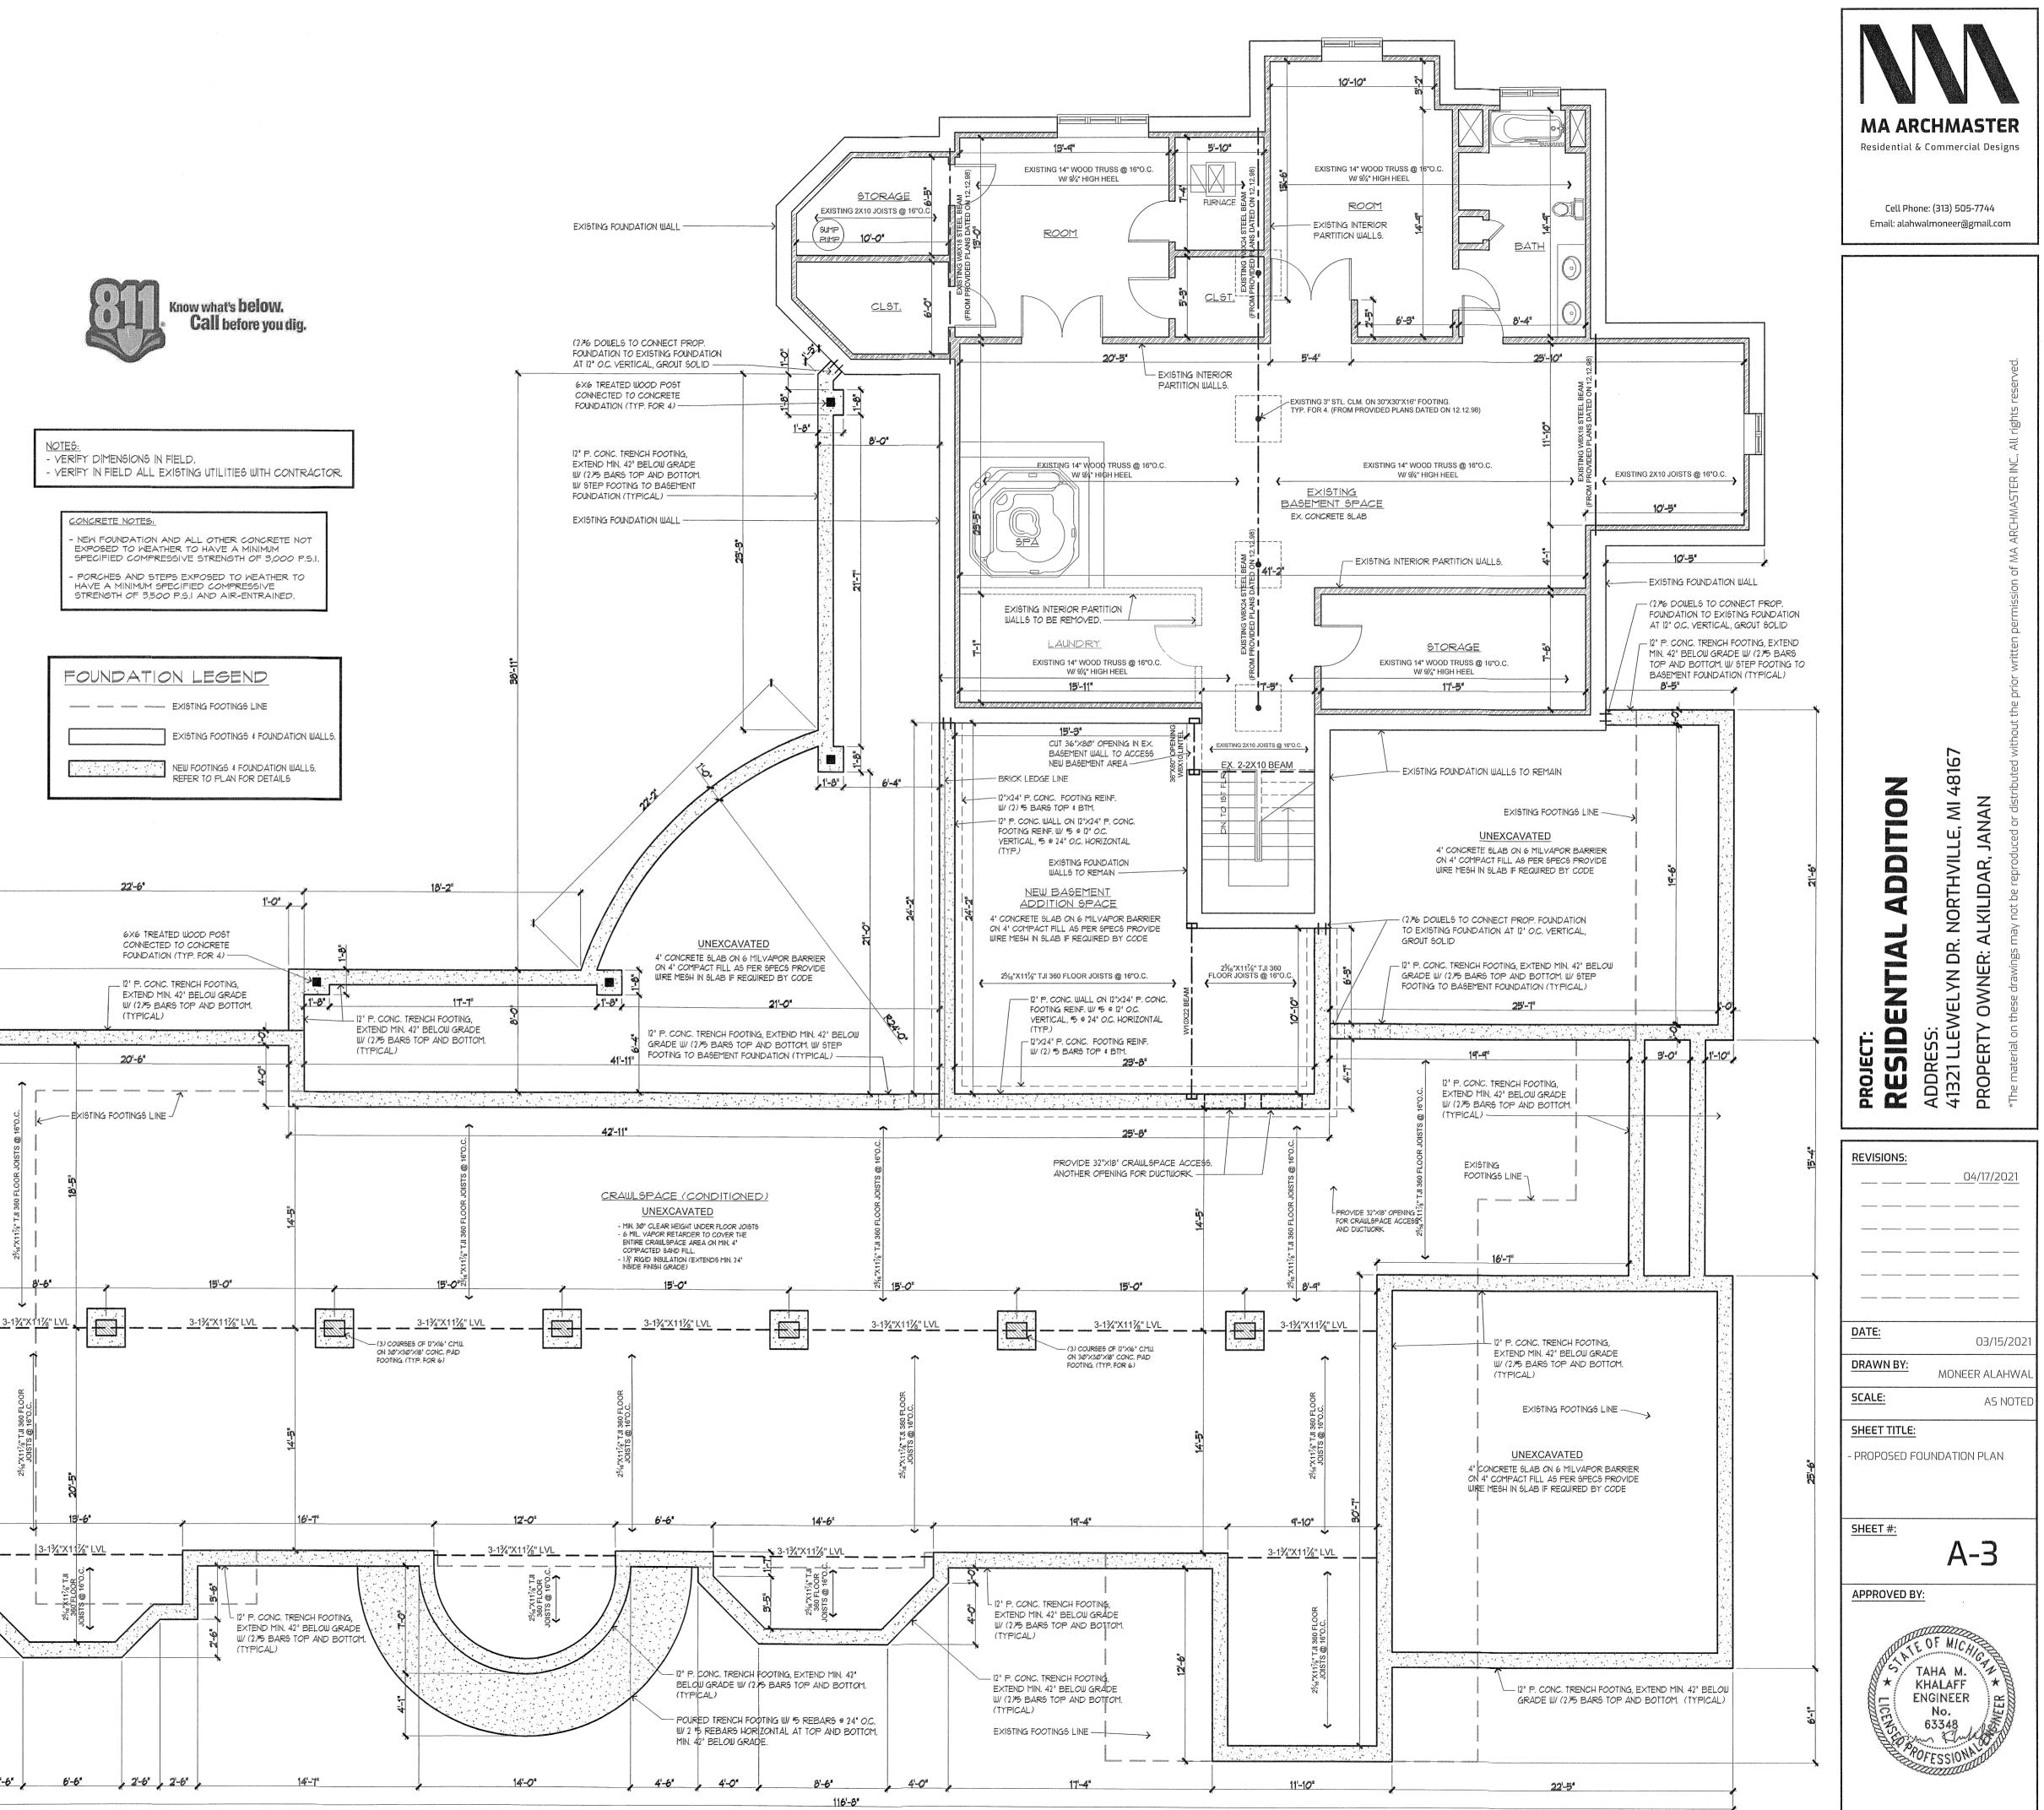

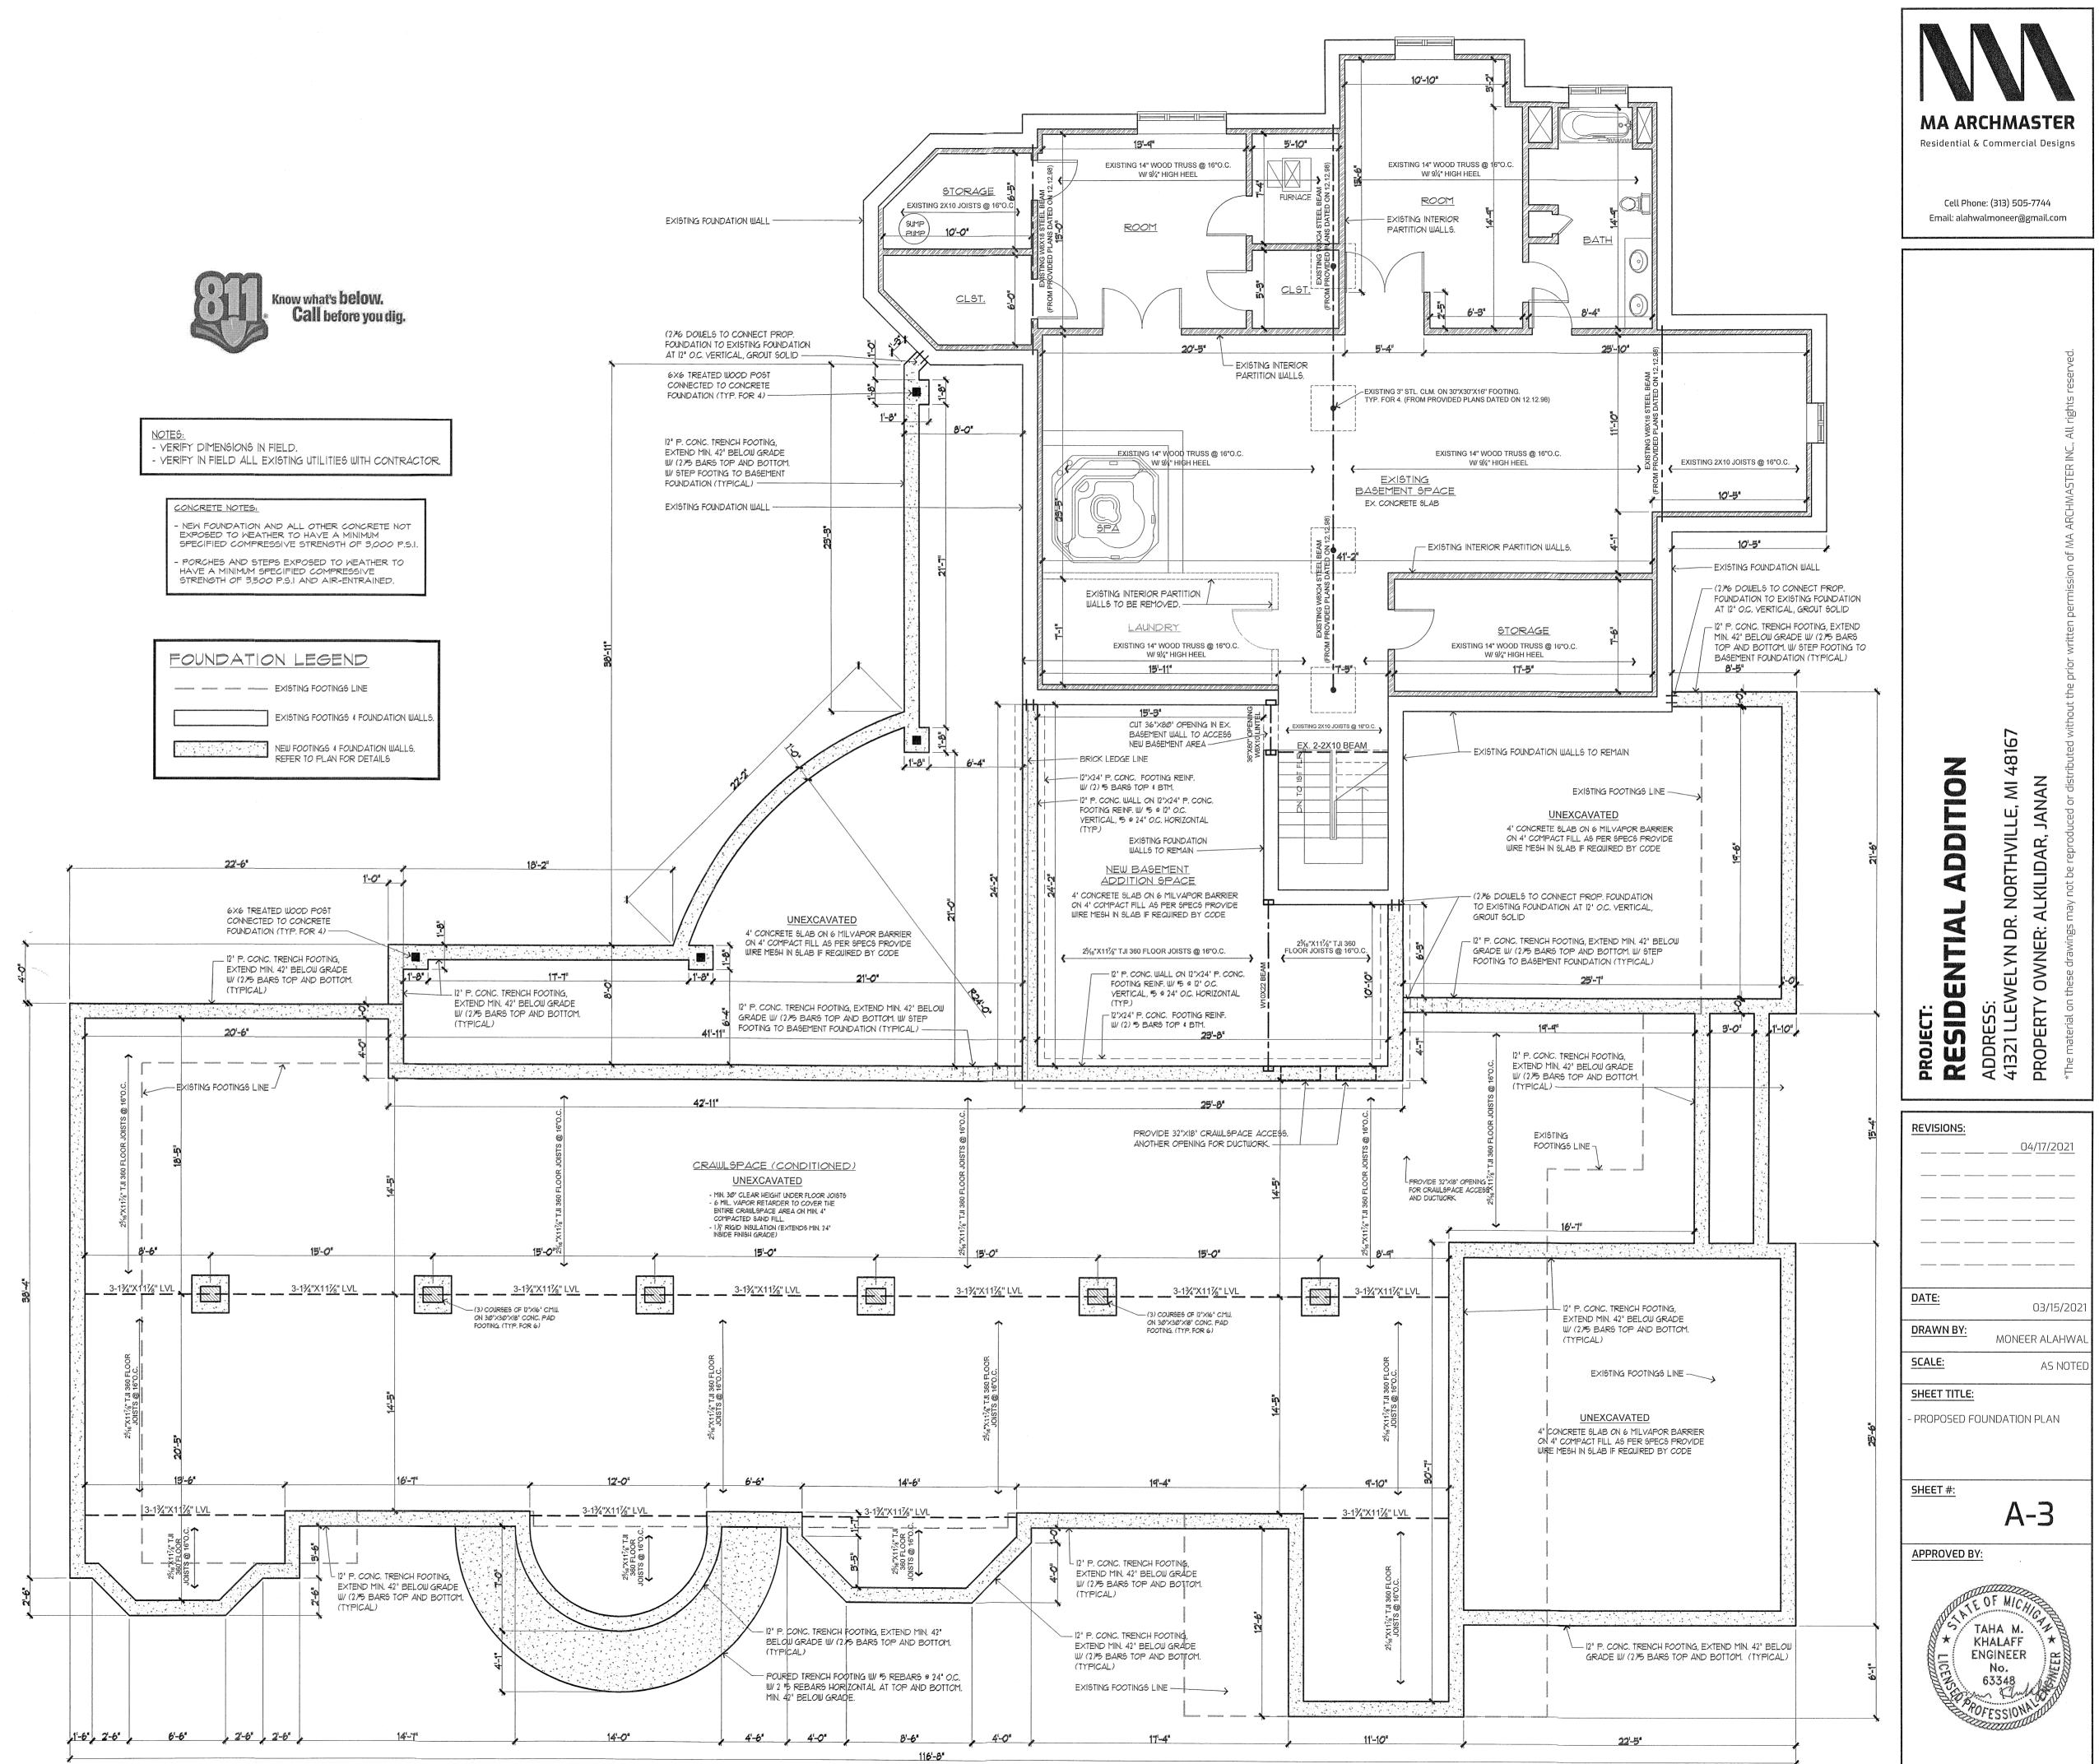


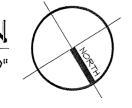




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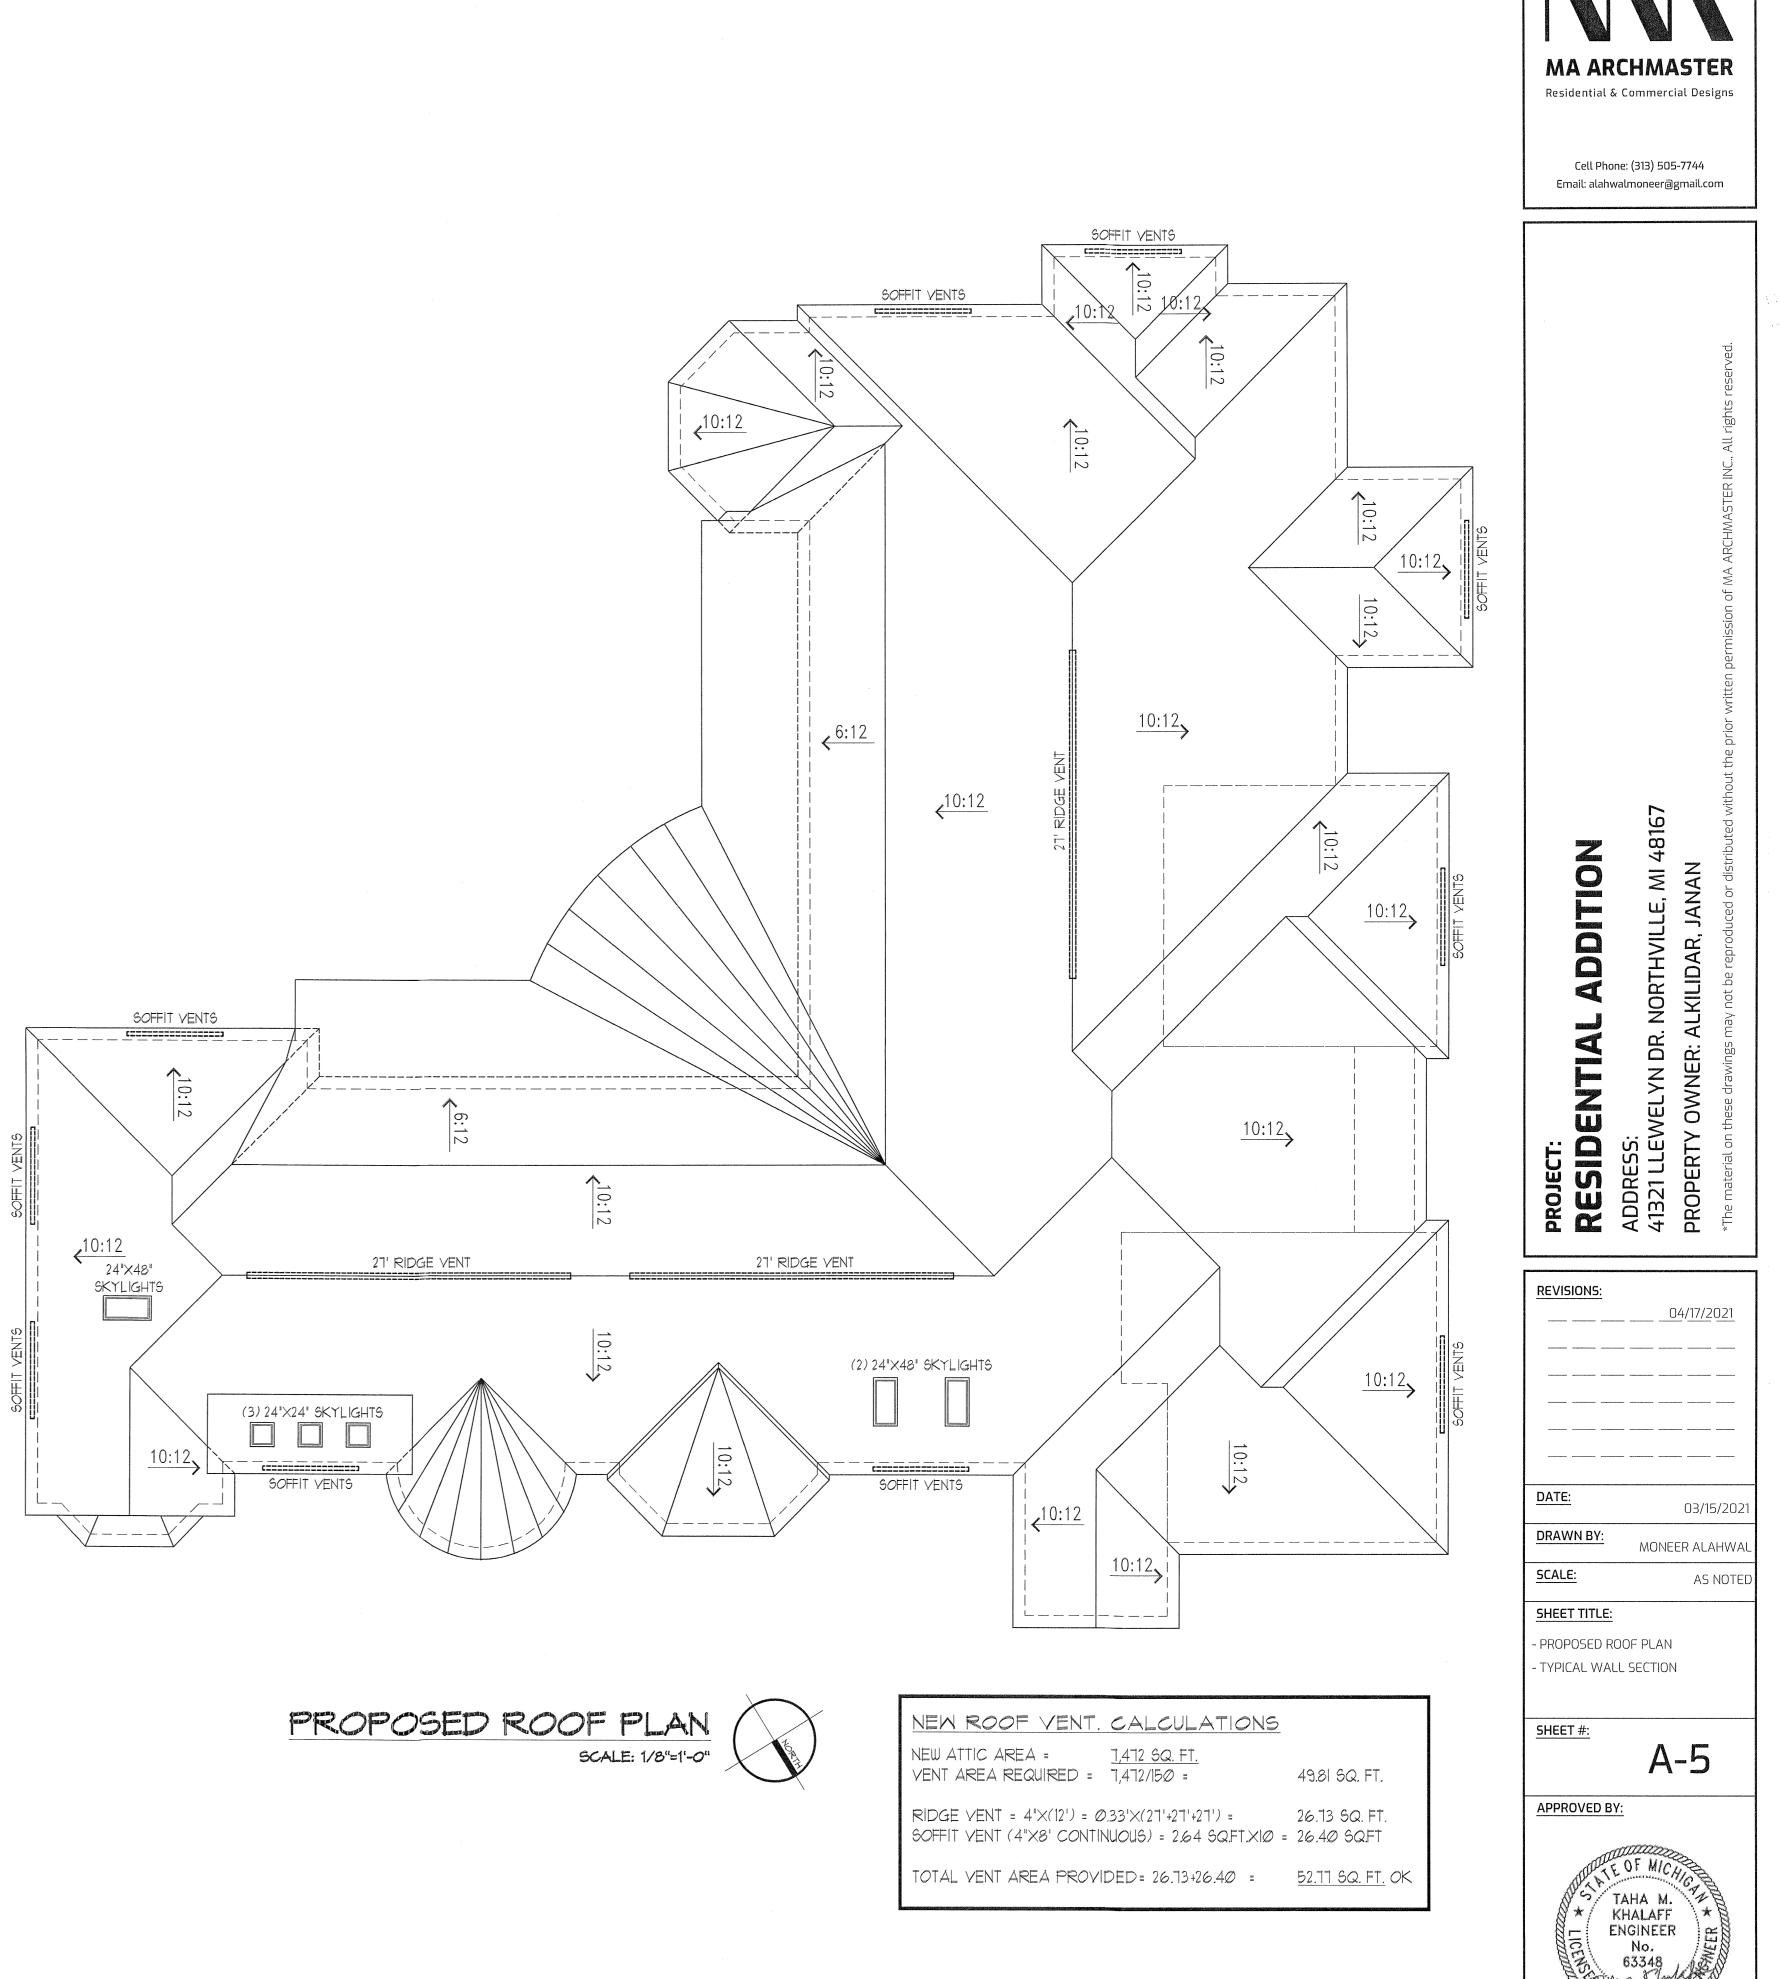
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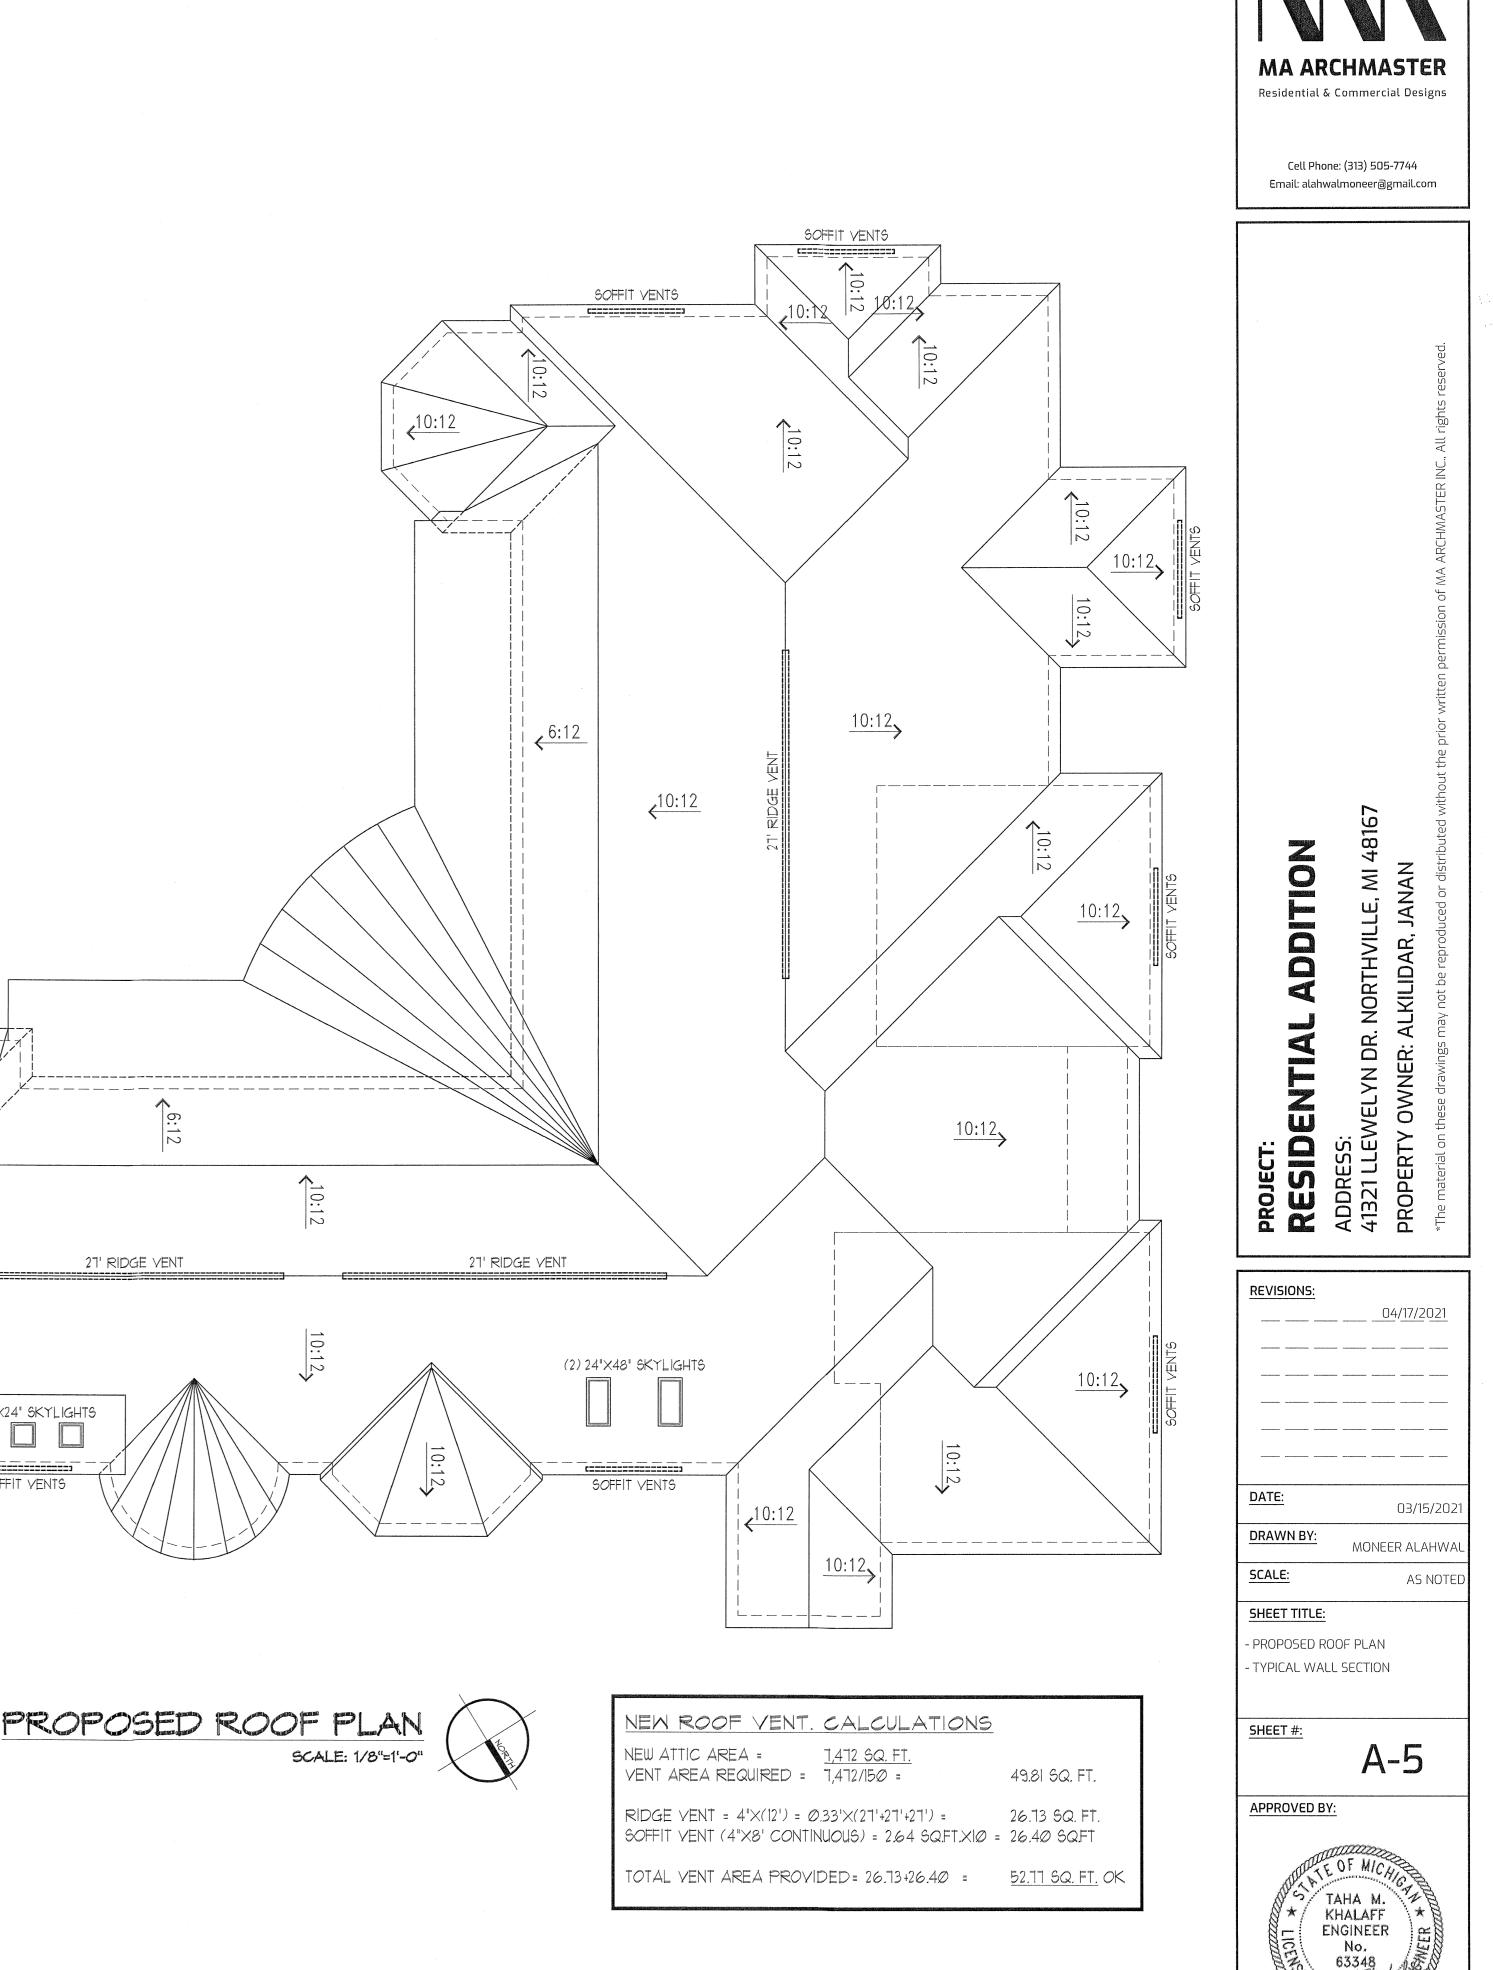
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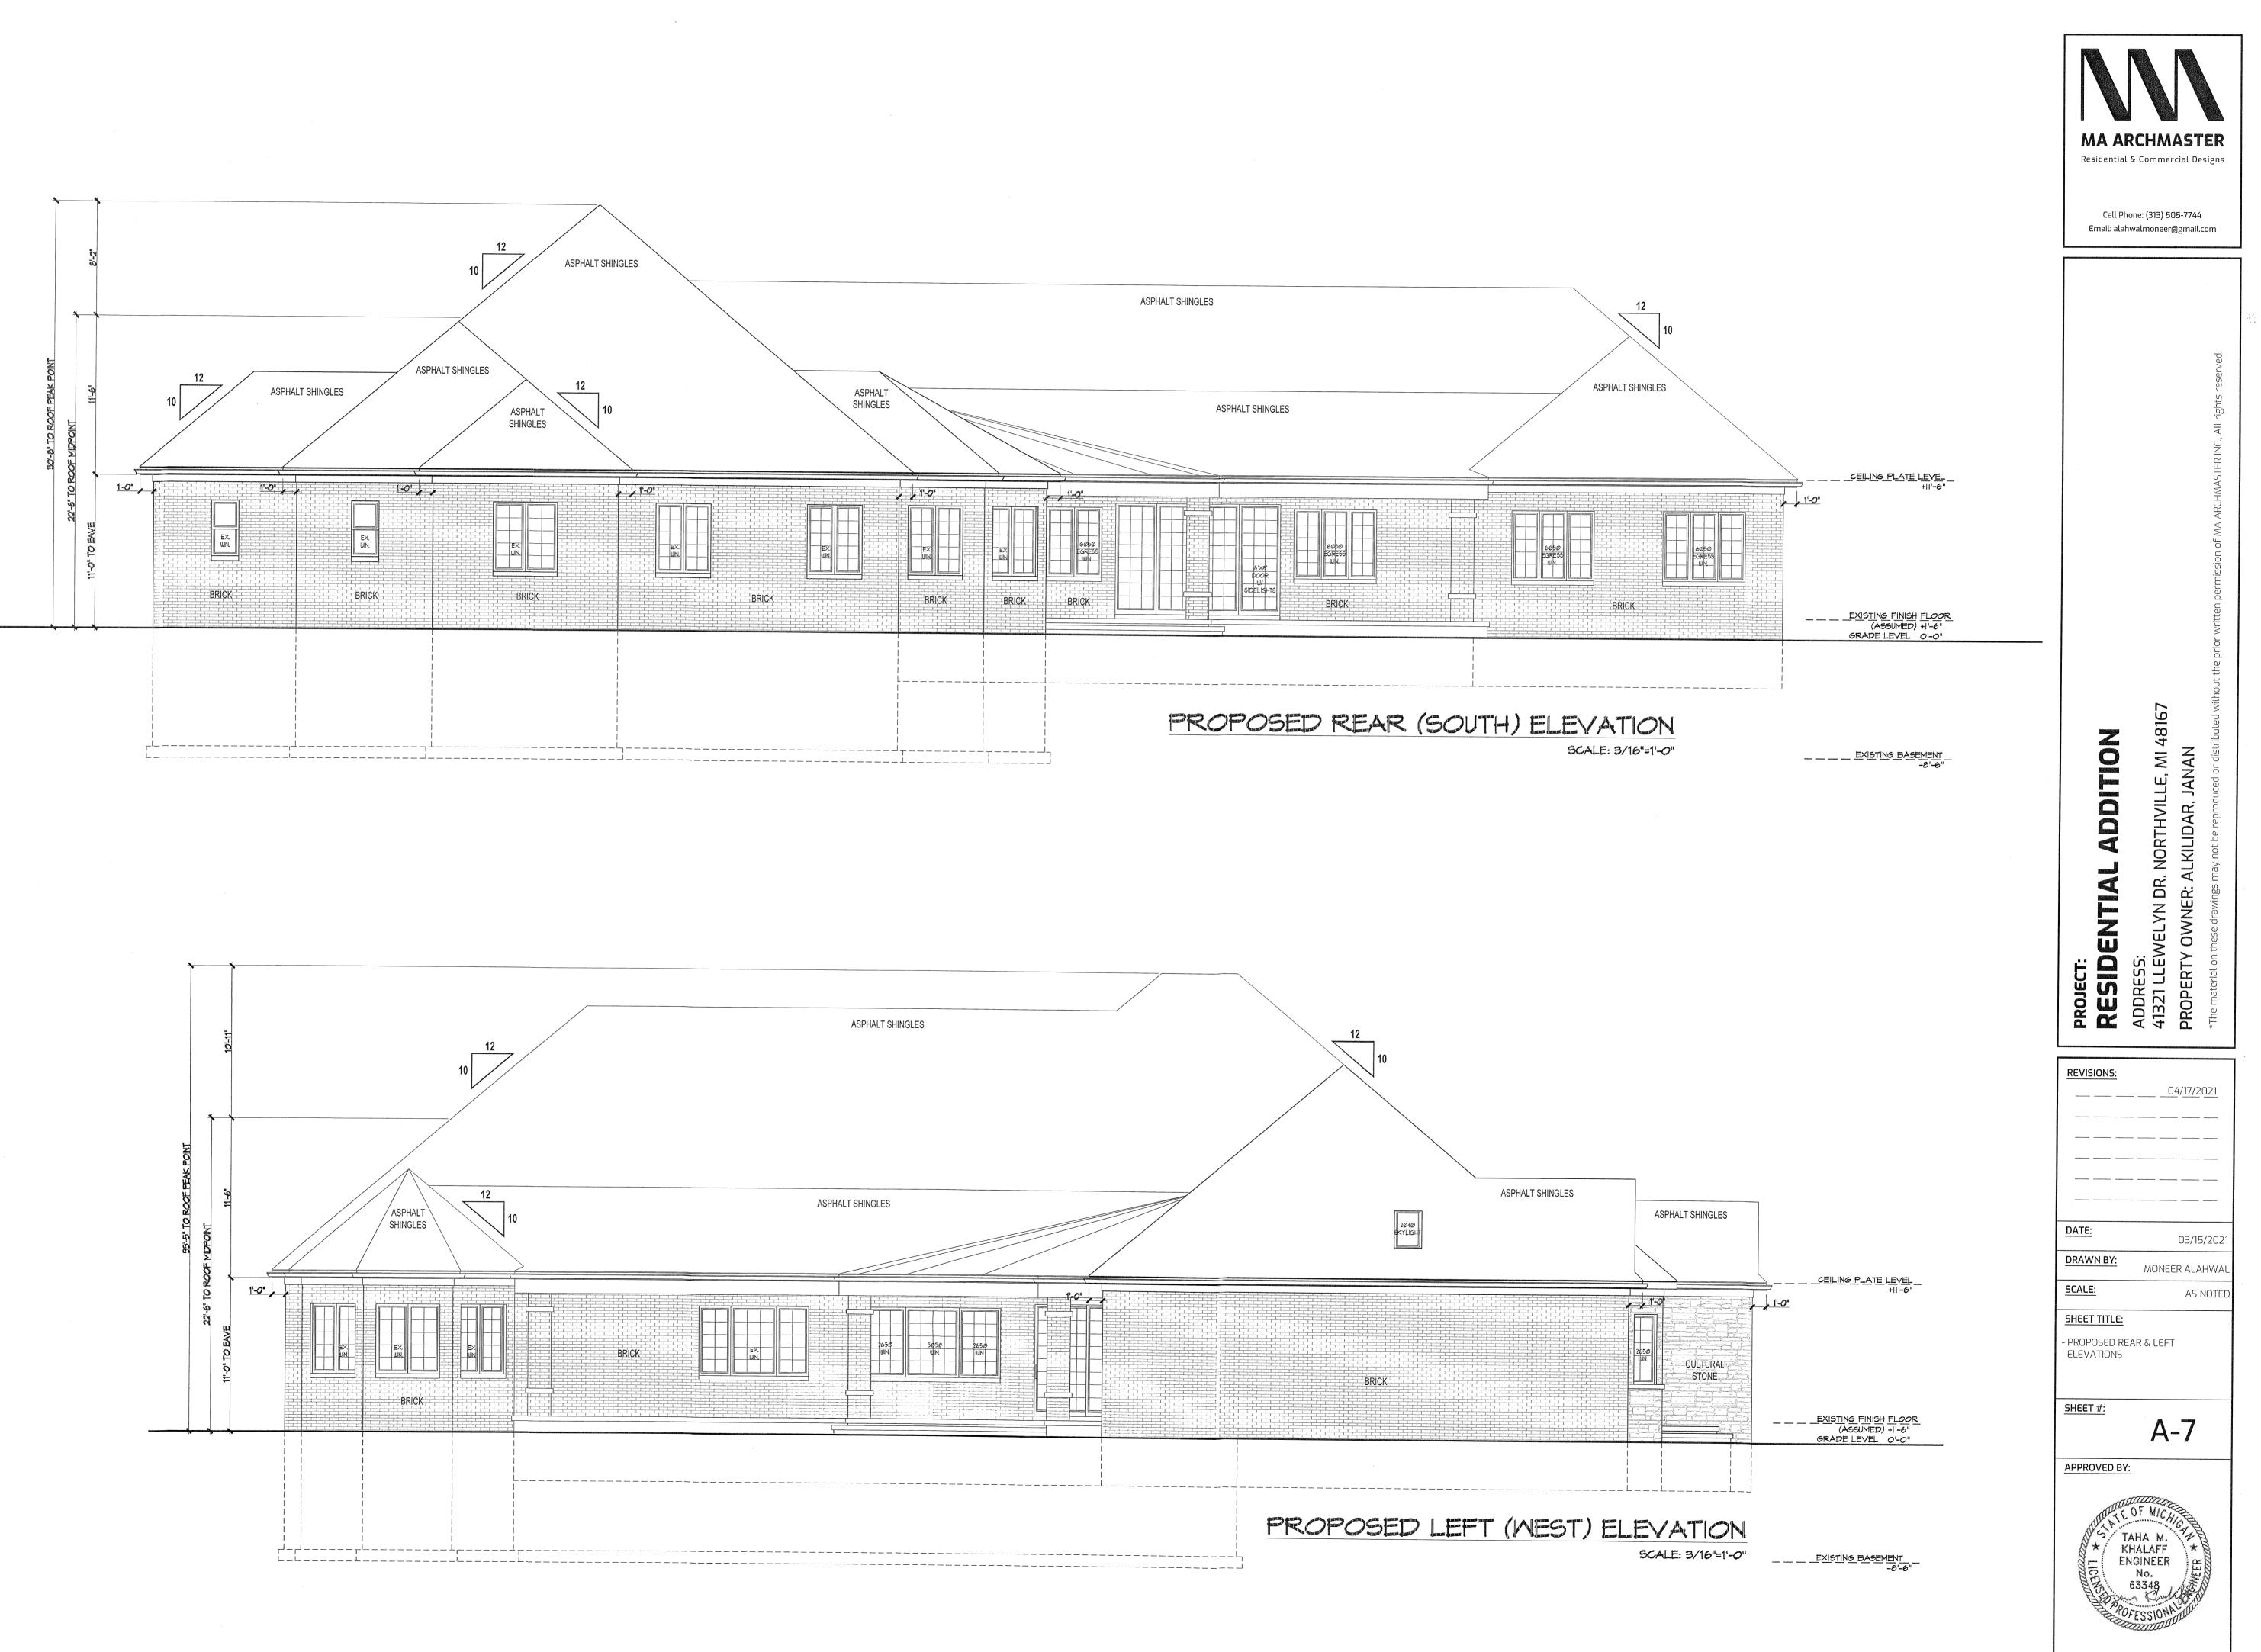


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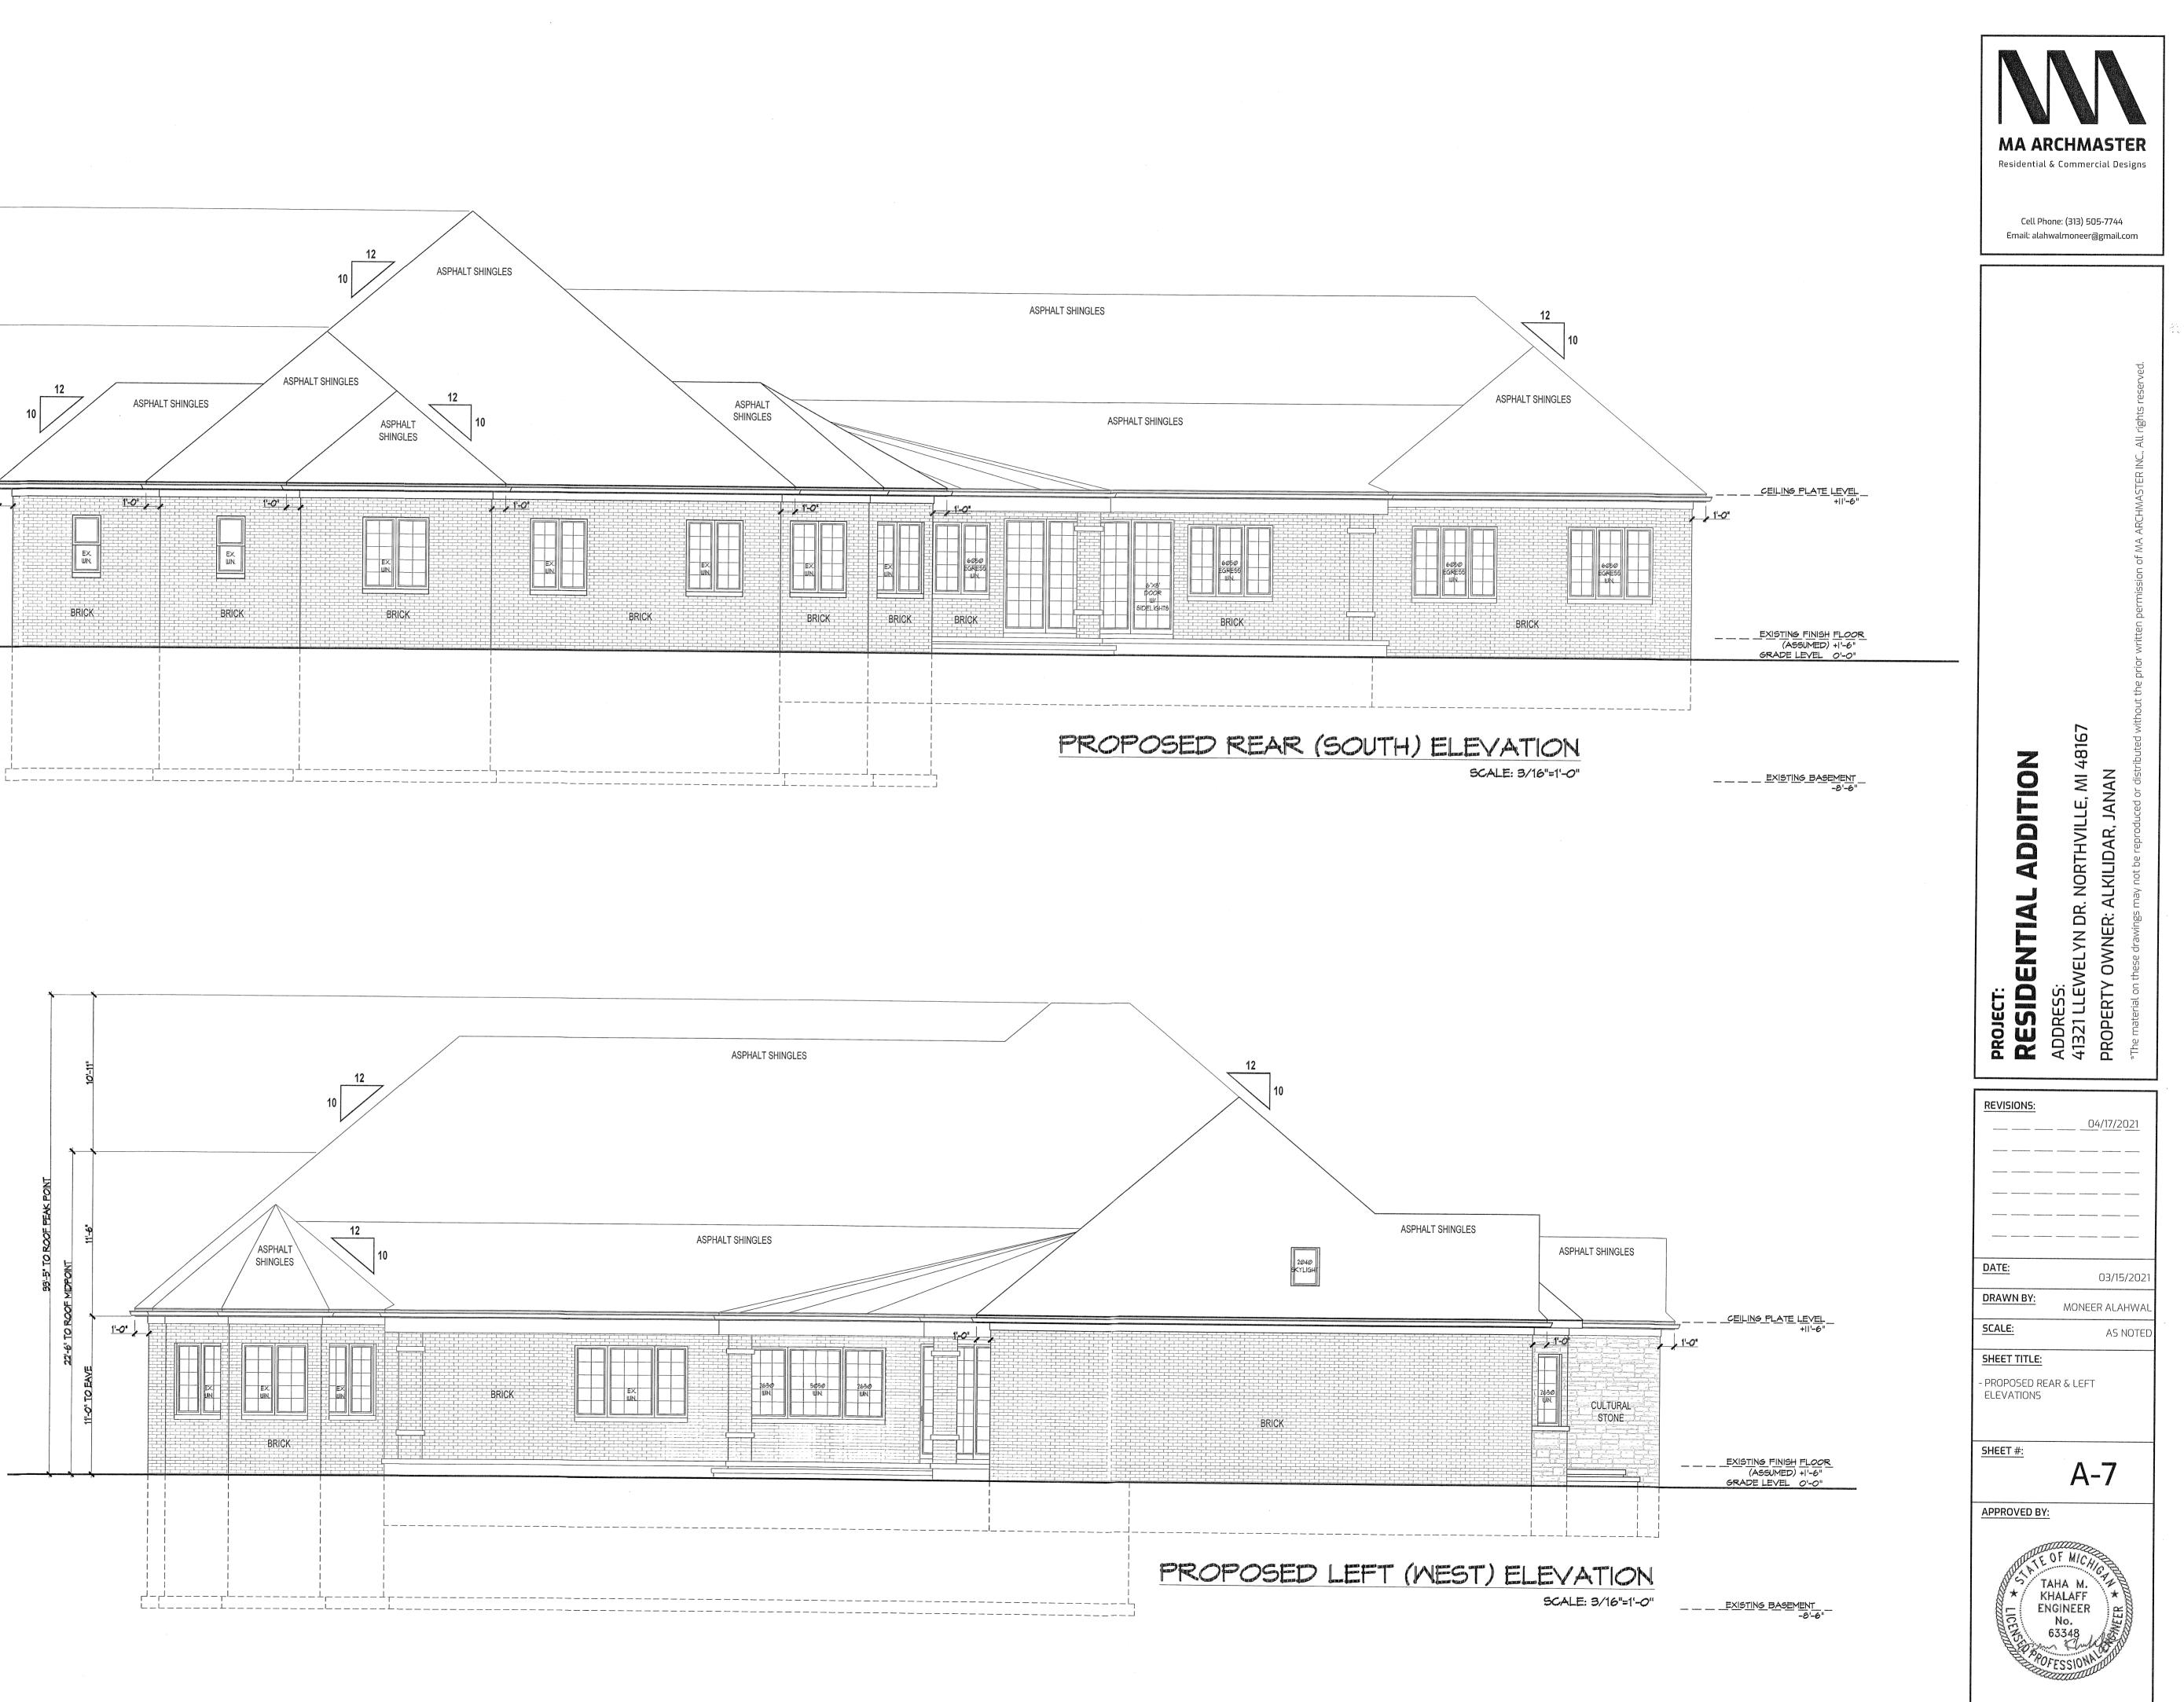


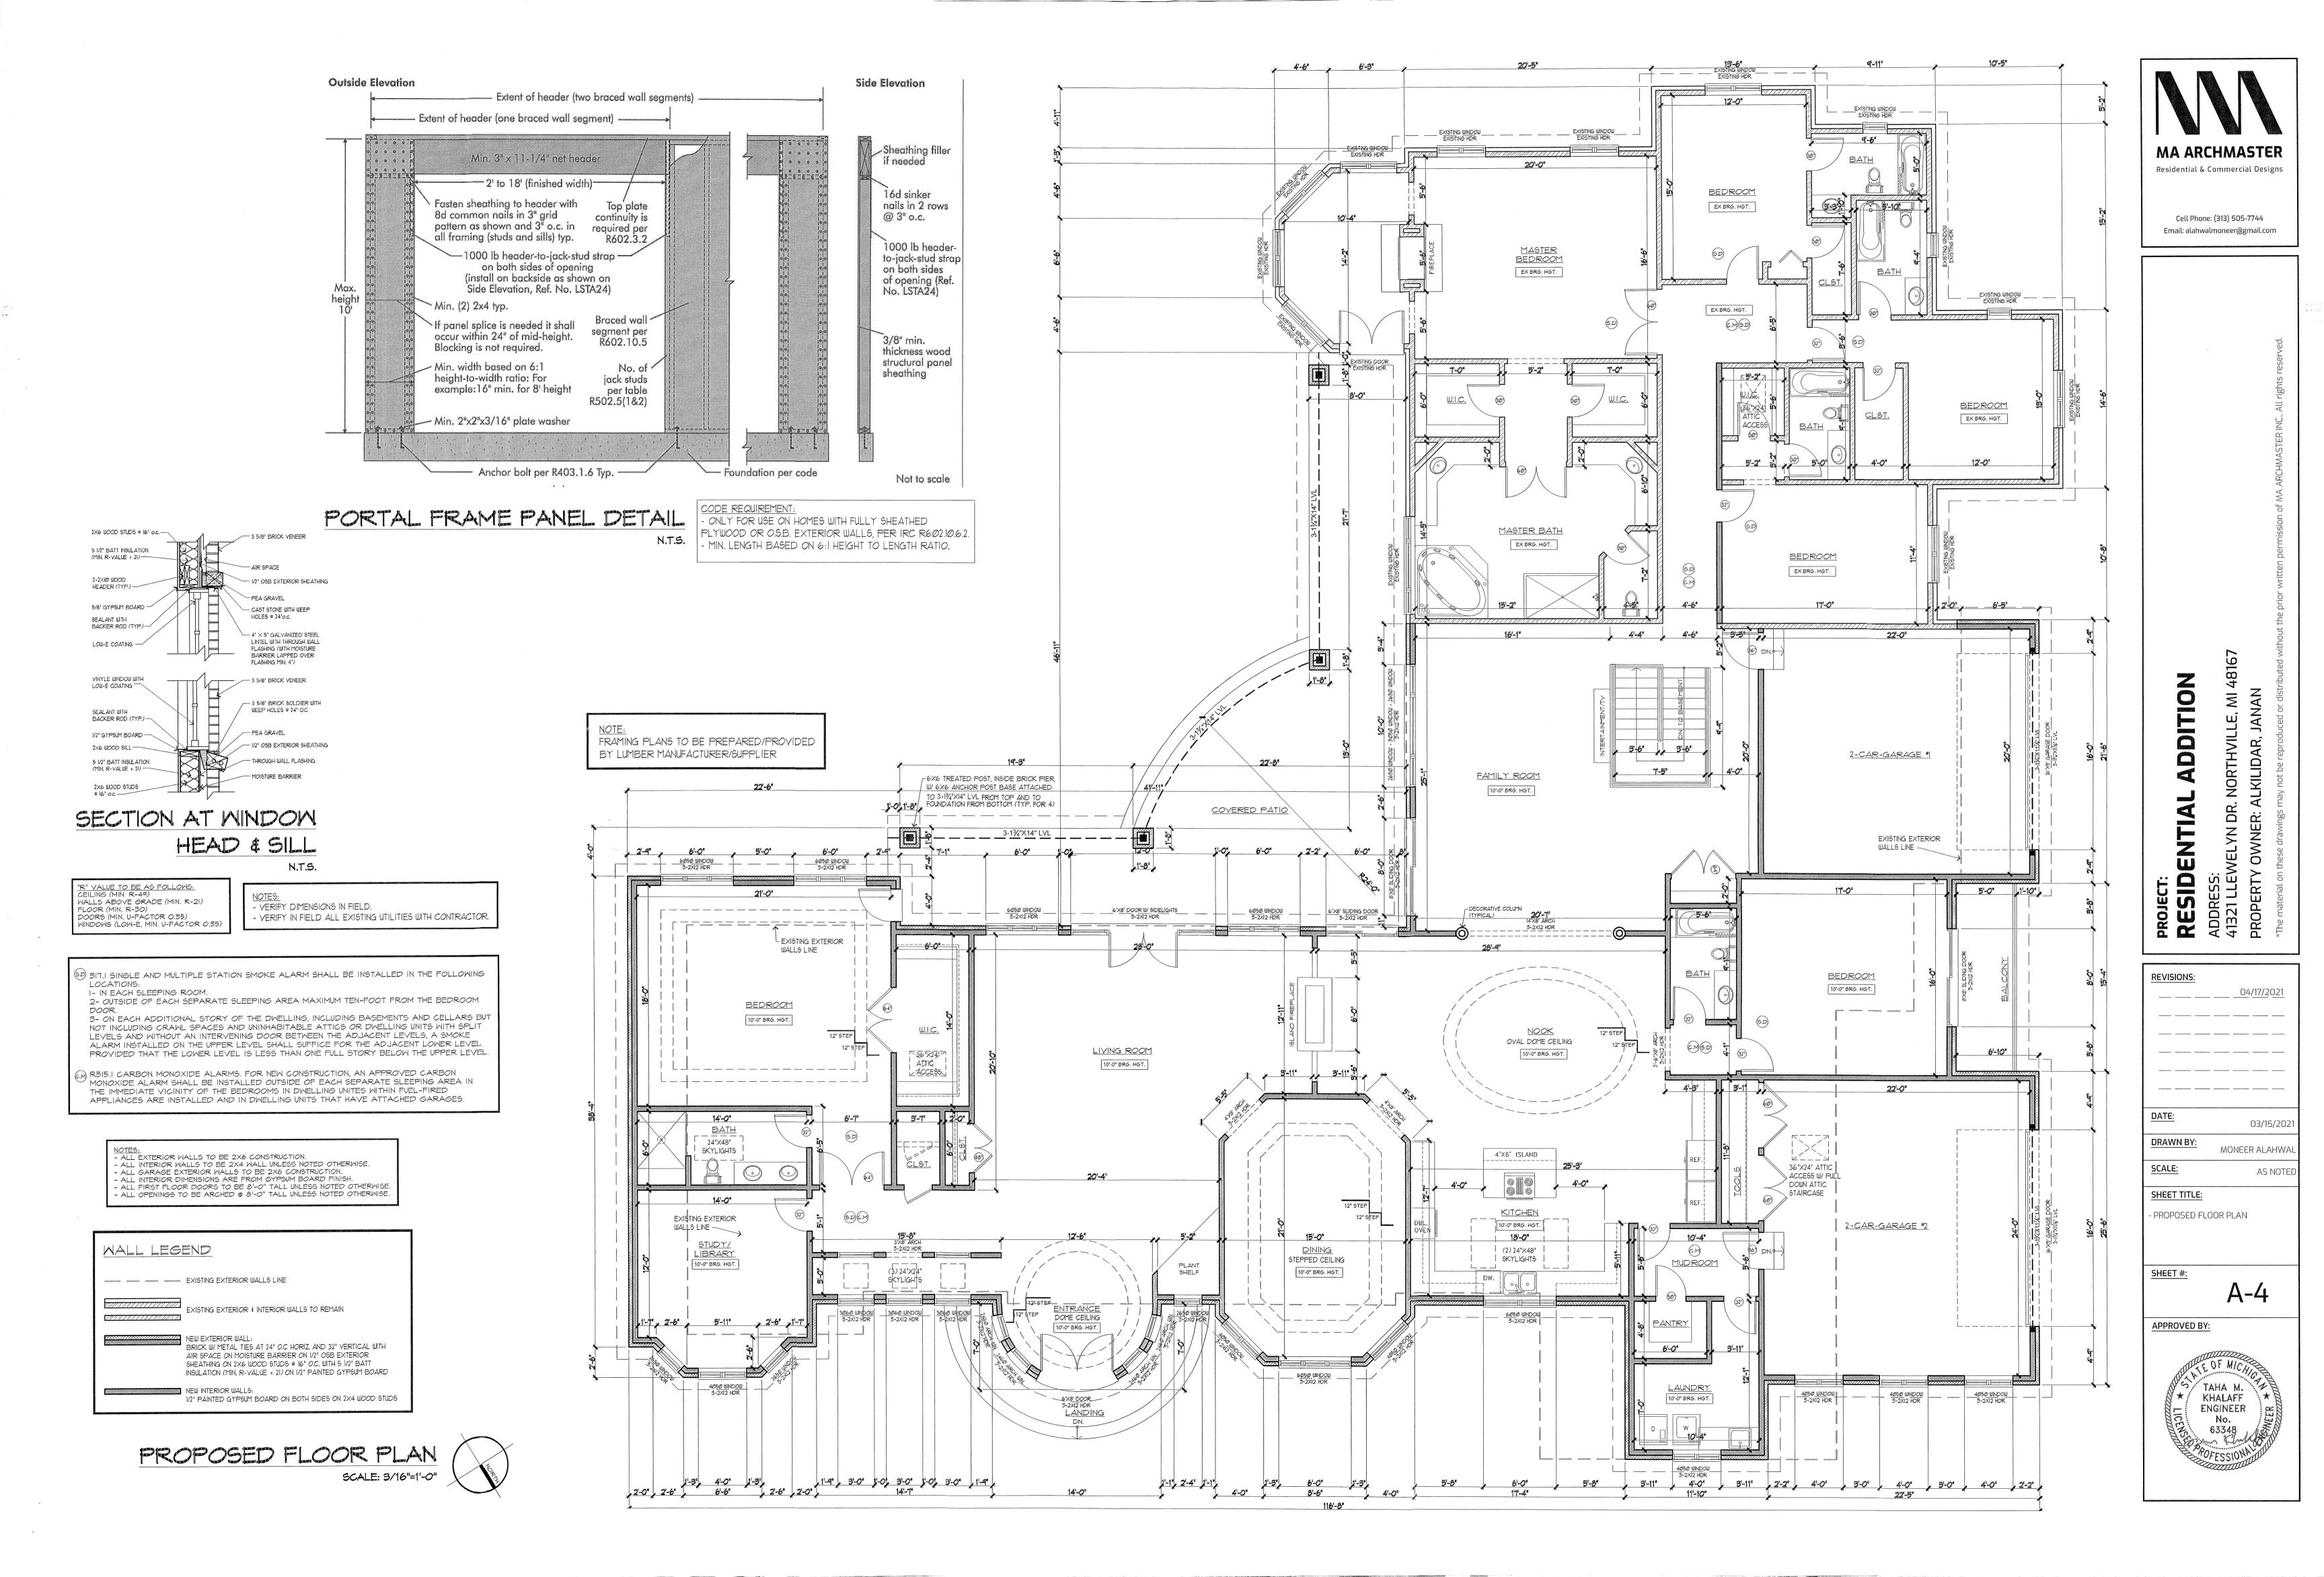

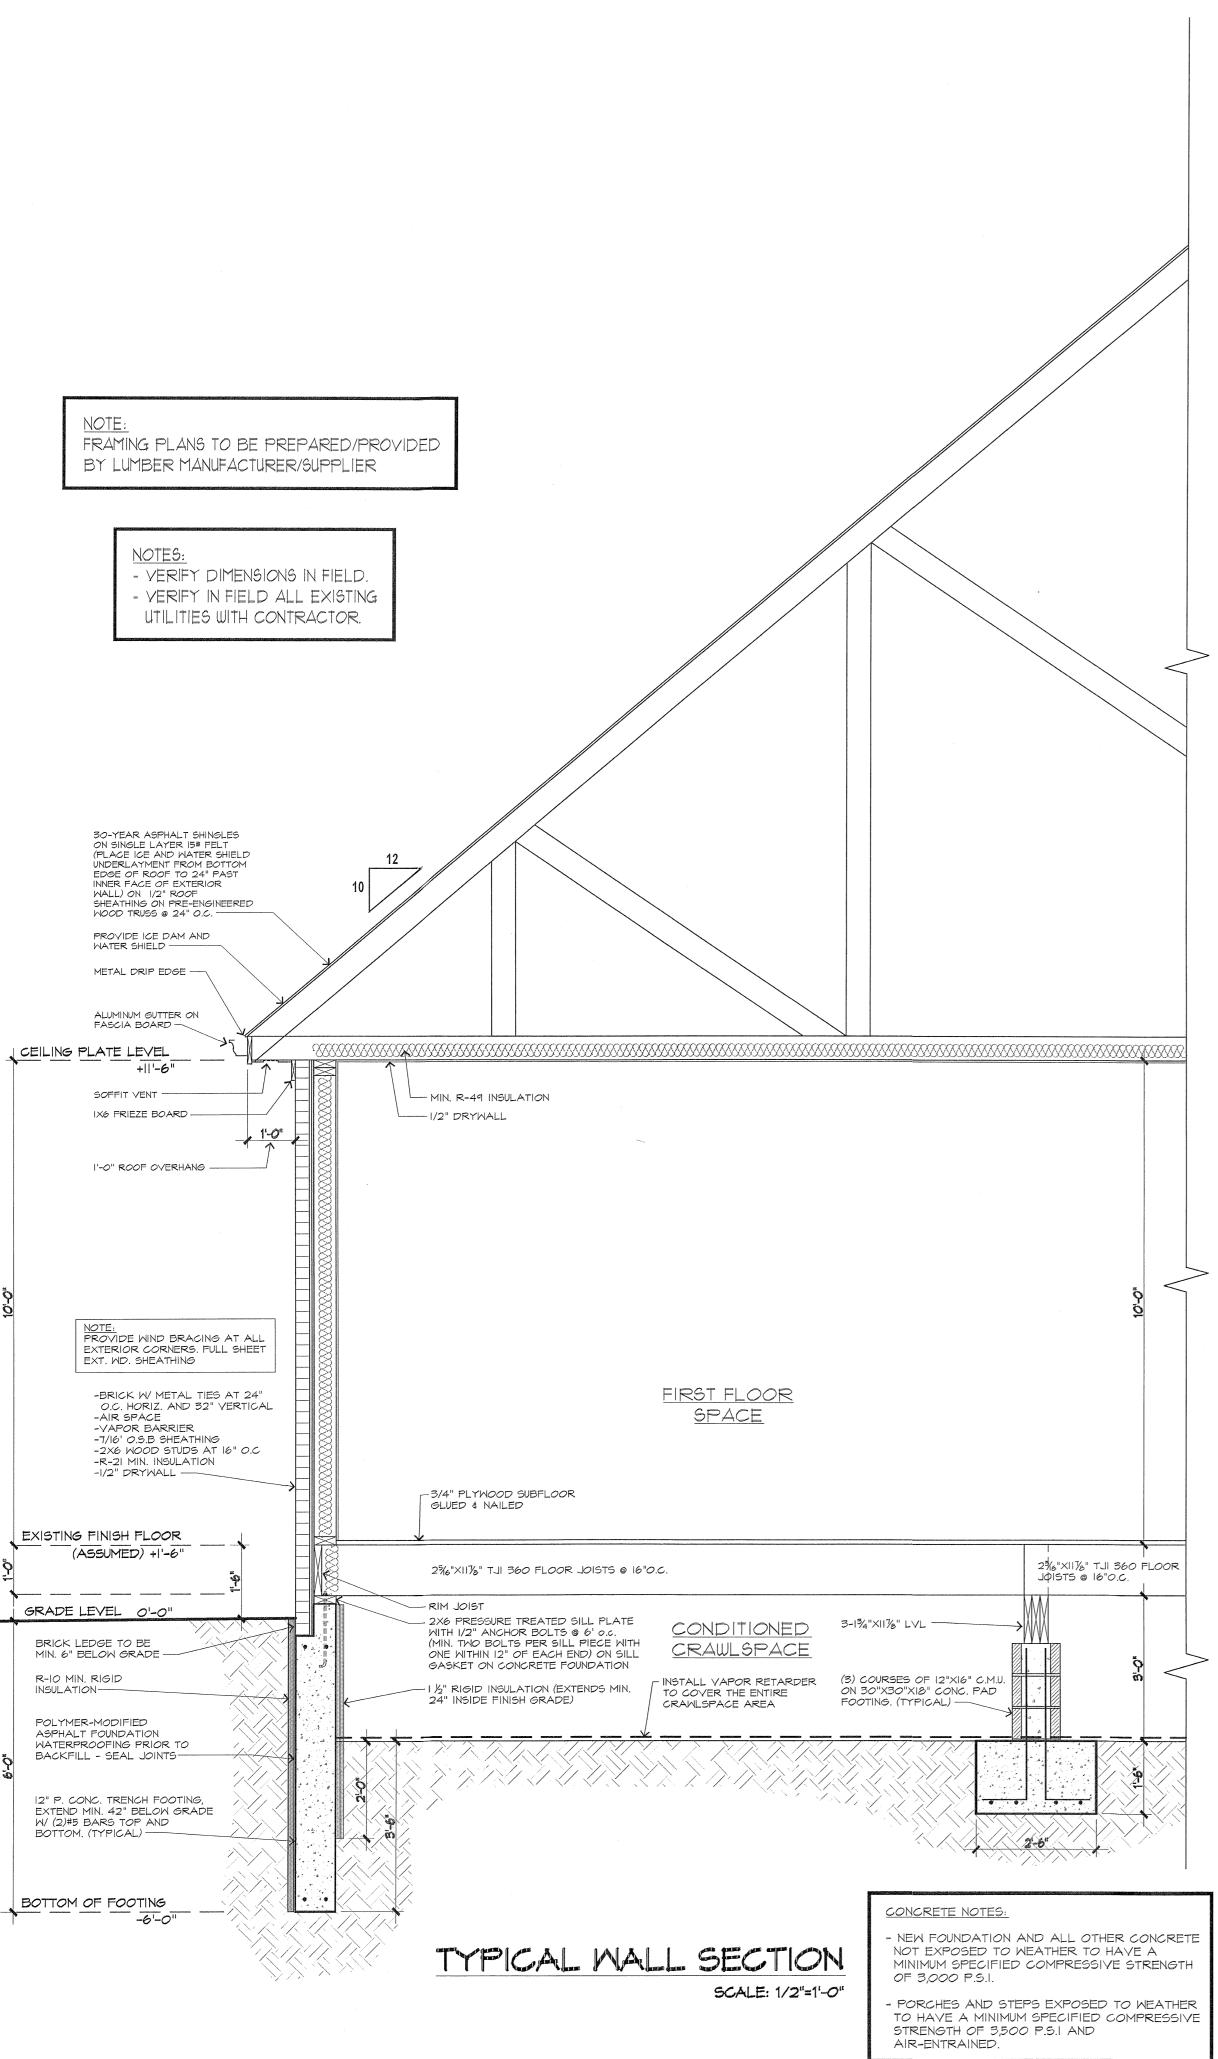
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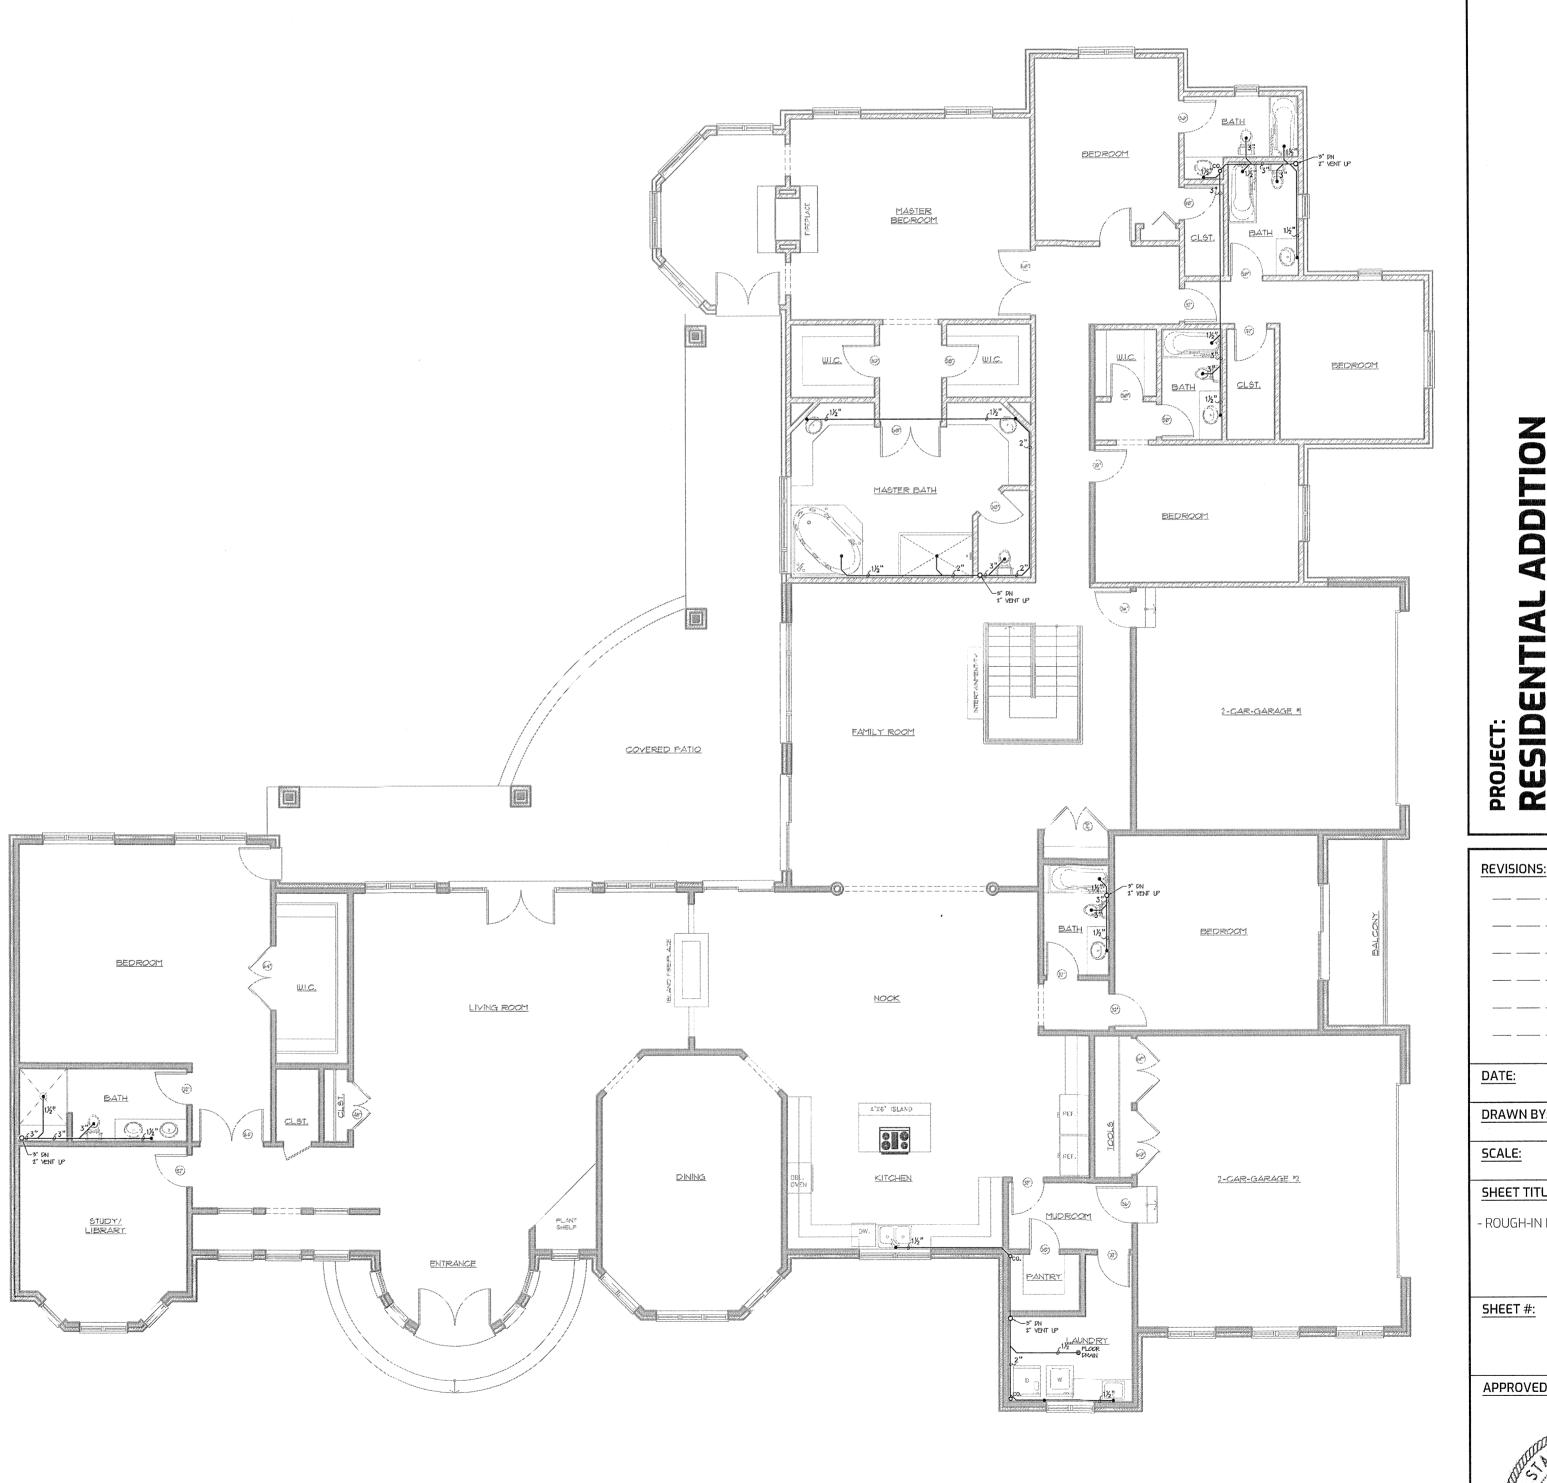
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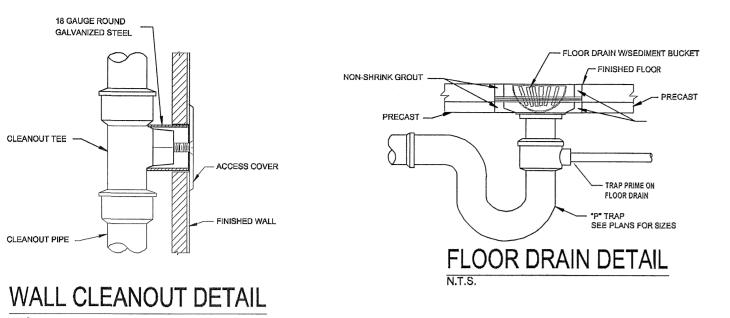
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FIRST FLOOR ROUGH-IN PLUMBING PLAN SCALE: 1/8"=1'-0"






- GENERAL PLUMBING NOTES IT IS THE RESPONSIBILITY OF THE OWNER TO SUBMIT THESE PLANS FOR APPROVAL PRIOR TO START OF WORK. ALL MATERIAL AND WORKMANSHIP SHALL CONFIRM TO THE REQ. OF APPLICABLE BUILDING CODES AND ORDINANCES. CONTRACTORS SHALL OBTAIN AND PAY FOR ALL THE PERMIT FEES THAT IS RELATED TO THEIR PART OF WORK. PRIOR TO BIDDING, CONTRACTORS MUST VISIT THE JOB SITE TO BECOME FAMILIAR WITH THE SCOPE OF WORK.
 PRIOR TO START OF WORK, CONTRACTORS TO CHECK AND VERIFY ALL DIMENSIONS ON THE FIELD, REPORT ANY ERRORS, OMISSIONS, OR POSSIBLE DISCREPANCIES TO THE OWNER! OR ARCHITECT.
- .
- PLUMBING CONTRACTOR SHALL VERIFY LOCATION AND SIZE OF EXISTING SANITARY AND WATER LINES. PERFORM ANY NEEDED CHANGES ON PLANS TO MEET JOB REQ. AS PER CODE. . THESE PLANS SHOW ROUGH IN REQ. FOR THE EQUIPMENTS DISCUSSED WITH OWNER AT THE START AND DURING THE DESIGN PROCESS. CONTRACTORS TO CHECK WITH OWNER FOR ANY CHANGES, SO THE SERVICE REQ. ARE SIZED AND
- ROUGHED IN PROPERLY.

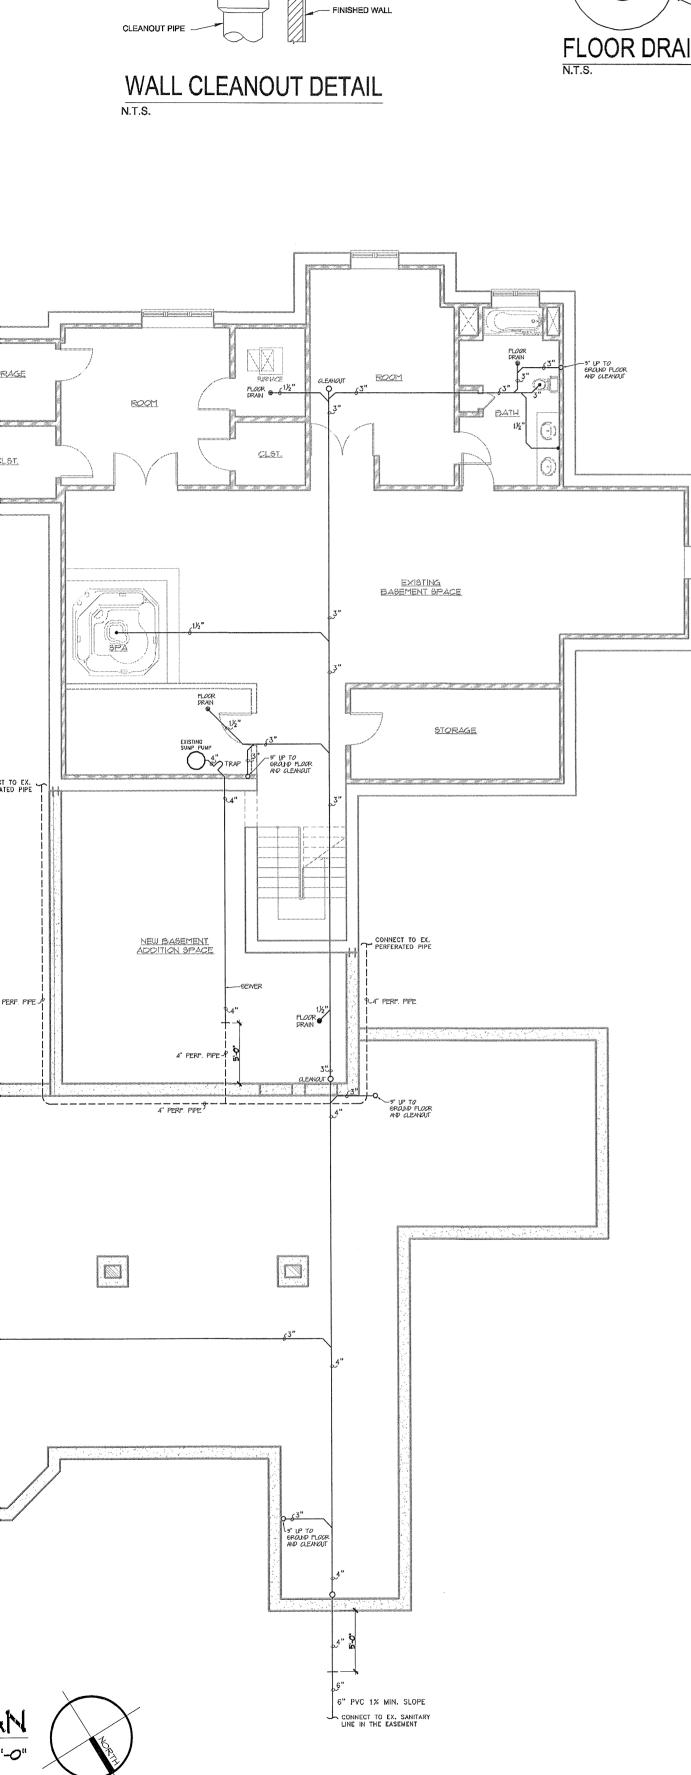- CONNECTIONS OF ALL EQUIPMENTS.
- · ALL SERVICES SHOWN WITH SYMBOLS AWAY FROM ANY WALL OR COLUMN SHOULD BE STUBBED OUT OF THE FLOOR TO
- CONTRACTORS ARE RESPONSIBLE TO CHECK THE SPECIFICATION SHEETS OF ALL EQUIPMENTS TO BE USED ON THIS JOB. TO PROPERLY LOCATE THE ROUGH -IN LOCATION AND TO SUPPLY ALL FITTINGS NEEDED TO DO THE FINAL ALL SERVICES SHOWN WITH SYMBOLS CENTERED ON FACE OF WALL STUBBED OUT OF THE WALL CENTERED AT HEIGHT SHOWN. DO NOT STUB OUT OF FLOOR AND RUN EXPOSED ON FACE OF WALL.
- A MAXIMUM OVERALL HEIGHT AS SHOWN.



- IMPORTANT NOTE: PLUMBING CONTRACTOR TO REMOVE ALL PIPING, FIXTURES, EQUIPMENTS THAT ARE NOT BEING USED FROM FLOOR, CEILING AND ROOF. WATER HEATER FLUE & FRESH AIR COMBUSTION PIPS BY PLUMBER.
- 3. PLUMBING CONTRACTOR TO VERIFY THE EXACT LOCATION OF THE EXISTING SANITARY LINE BEFORE STARTING TO RUN NEW LINES. VERIFY SIZE AND DIRECTION OF FLOW. PROVIDE TRAP PRIMERS ON FLOOR DRAINS PER MPC 1002.4
- PROVIDE A RPZ BACKFLOW PREVENTER AFTER THE METER PER MPC 608. PROVIDE TEMPERING VALVE FOR ALL HAND SINKS.
- REMOVE AND CAP ALL EXISTING PLUMBING NOT BEING USED. VERIFY CONDITIONS OF ALL EXISTING PLUMBING PRIOR TO START OF WORK
- PROVIDE VENTS AS REQUIRED BY LOCAL CODES.
- 10. RE-USE WHEN POSSIBLE ALL EXISTING UNDER GROUND PLUMBING. II. PROVIDE VENTS REQUIRED BY CODE. VENT PIPES TO BE CONCEALED INSIDE WALLS ADDED TO MAIN VENT
- PIPE THRU-ROOF, PROVIDE THE REQUIRED DISTANCE FROM FRESH AIR INTAKE DEVICES ON ROOF. 12. PROVIDE CLEAN OUTS AT THE END OF DRAIN # AT CHANGE OF DIRECTION.

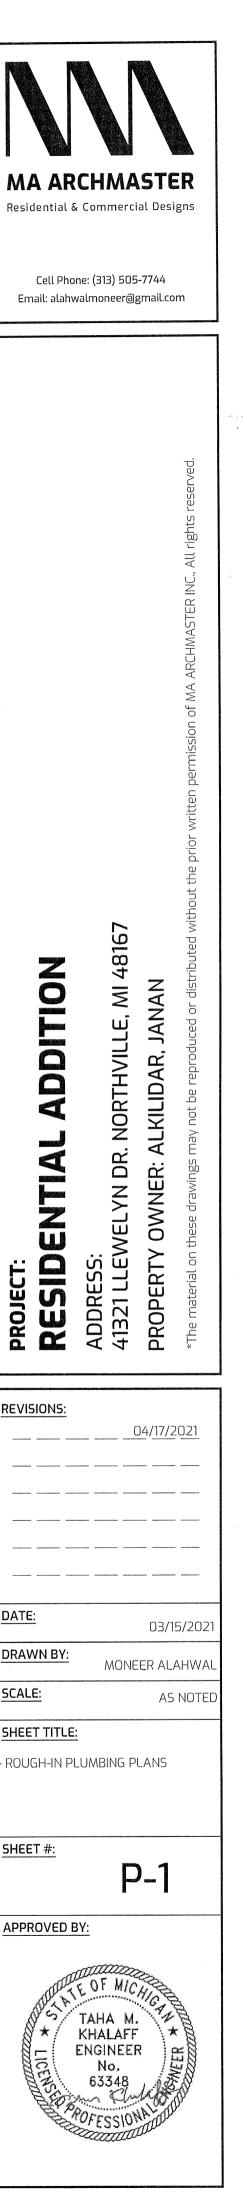

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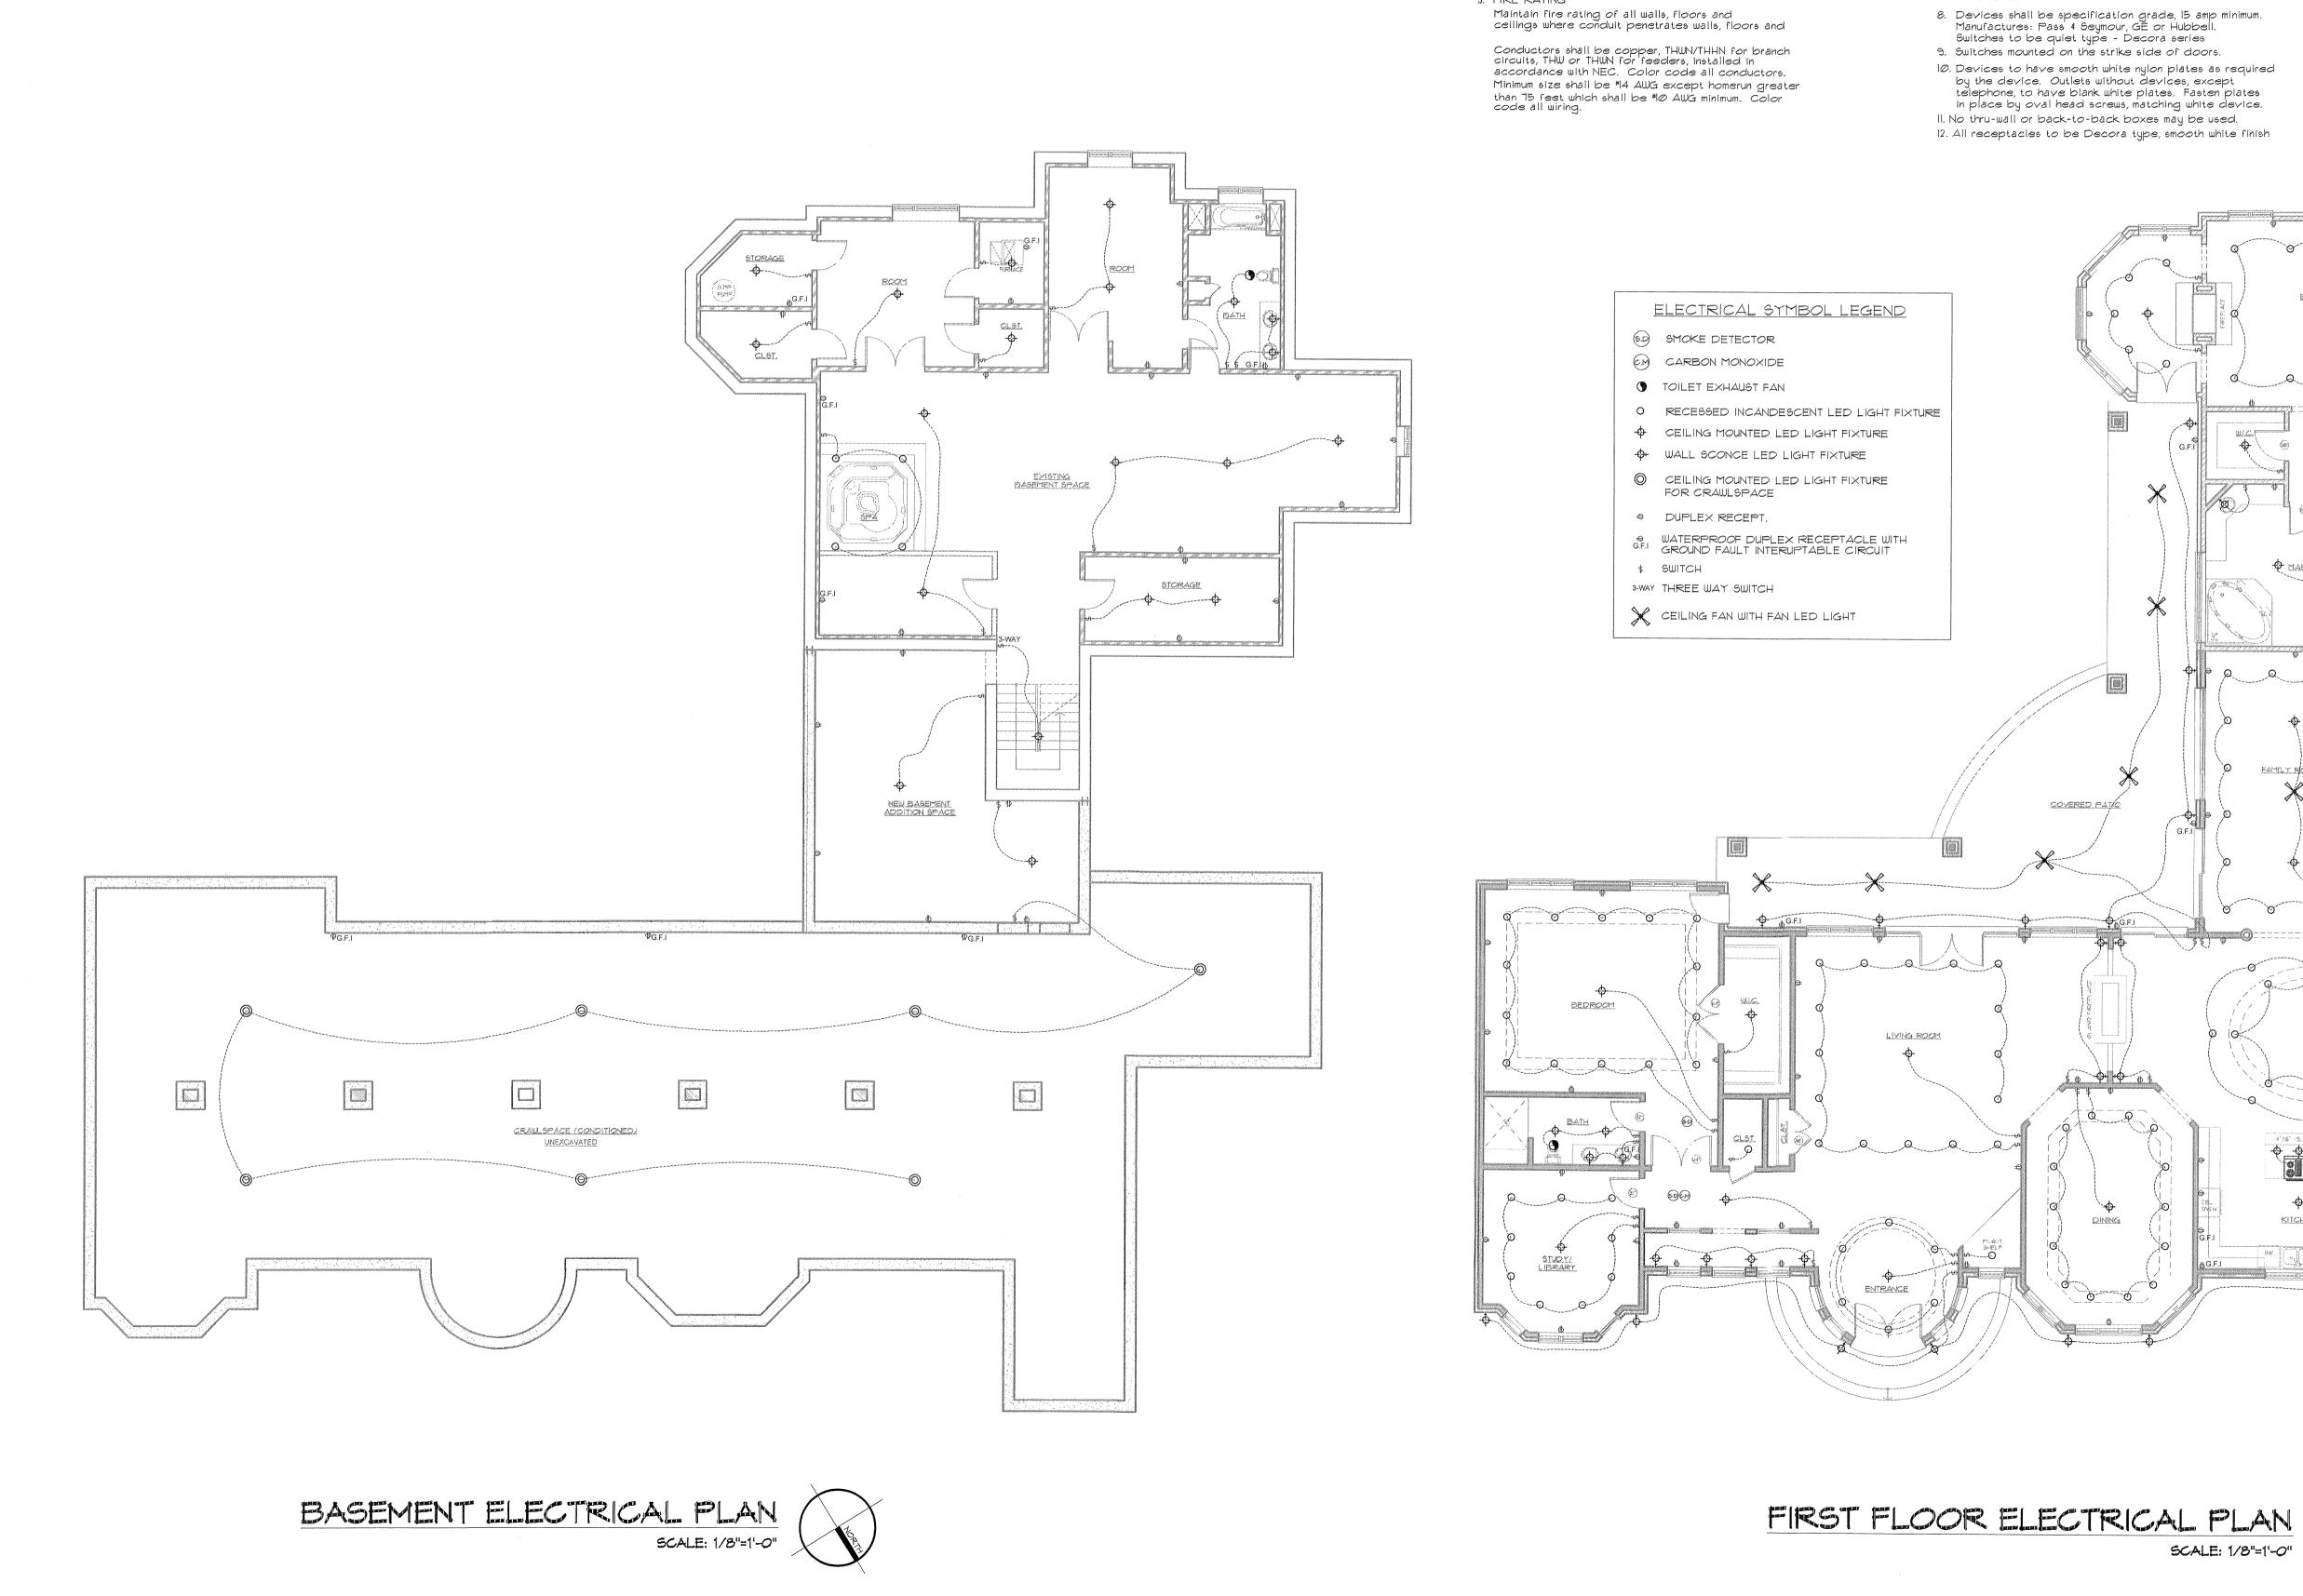
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SHEET #:

APPROVED BY:

TAHA M. KHALAFF

ENGINEER



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ELECTRICAL SPECIFICATIONS

SECTION 16111 - CONDUITS

1. ELECTRIC METALLIC TUBING OF INTERMEDIATE METALLIC CONDUIT: Dry locations.

- 2. RIGID GALVANIZED STEEL: Wet locations.
- 3. Not used
- 4. FITTINGS
- A. Compression with insulated throats. B. Threaded hubs for rigid at wet locations. 5. SUPPORTS: In accordance with NEC
- 6. EMPTY CONDUITS A. Pull cords.
- B. Tags.
- 7. SIZE
- A. 1/2 inch minimum. B. 3/8 inch minimum flexible
- 8. ROUTING AND LOCATION A. Parallel to building lines where exposed to view. B. As approved by Architect. 9. FIRE RATING

SECTION 16140 - WIRING DEVICES I. Outlet Boxes: Galvanized stamped steel or plastic for all

- interior locations. Mount all boxes so that covers and plates will mount flush with the wall and ceiling finished surface. Provide plaster rings as necessary. Goof rings are not acceptable. 2. Architect reserves the right to make minor changes.
- 3. All bars, hangars or caddy clips shall be galvanized steel. No wooden supports or makeshift devices will be allowed. 4. Switches receptacles, and covers shall be white.
- 5. Provide rain tight metal boxes with threaded conduit holes and cast metal face plates with spring hinged
- caps for wet locations. 6. Except as noted locate wall outlets at listed below:
- When installed in masonry walls, located bottom of box at nearest masonry joint to dimension indicated... where outlets occur above counters or cabinets, correlate height of outlet with equipment so device will clear all trim.
- 8. Devices shall be specification grade, 15 amp minimum. Manufactures: Pass ∉ Seymour, GE or Hubbell. Switches to be quiet type Decora series
- 10. Devices to have smooth white nylon plates as required

Switches 48" D. Kit & Bath 48" Receptacles 18" E. Thermostats 60" C. Telephone 18" F. Tele (wall) 60"

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SCALE: 1/8"=1'-0"

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SECTION 16450 - GROUNDING

Grounding shall be in accordance with NEC Article 250.

Provide green coded continuous grounding conductor, in addition to neutral for each circuit run as shown in the panel schedules. Neutral shall not be used as a ground for equipment. Equipment ground bonded to neutral at main service entrance only.


SECTION 16500 - LIGHTING 1. REQUIREMENTS

All light fixtures shall be specified by owner and purchased and installed by Contractor

2. All light fixtures shall be located per architectural. NOTE:

BEDROOM OUTLETS: ALL BRANCH CIRCUITS THAT SUPPLY 120 VOLT, SINGLE PHASE, 15 AND 20 AMP OUTLETS, INCLUDING LIGHTS, RECEPTACLES AND SMOKE

DETECTORS INSTALLED IN BEDROOMS SHALL BE PROTECTED BY A COMBINATION TYPE ARC-FAULT CIRCUIT INTERRUPTER INSTALLED TO PROVIDE PROTECTION OF THE ENTIRE BRANCH PER M.R.C. E3902.II.

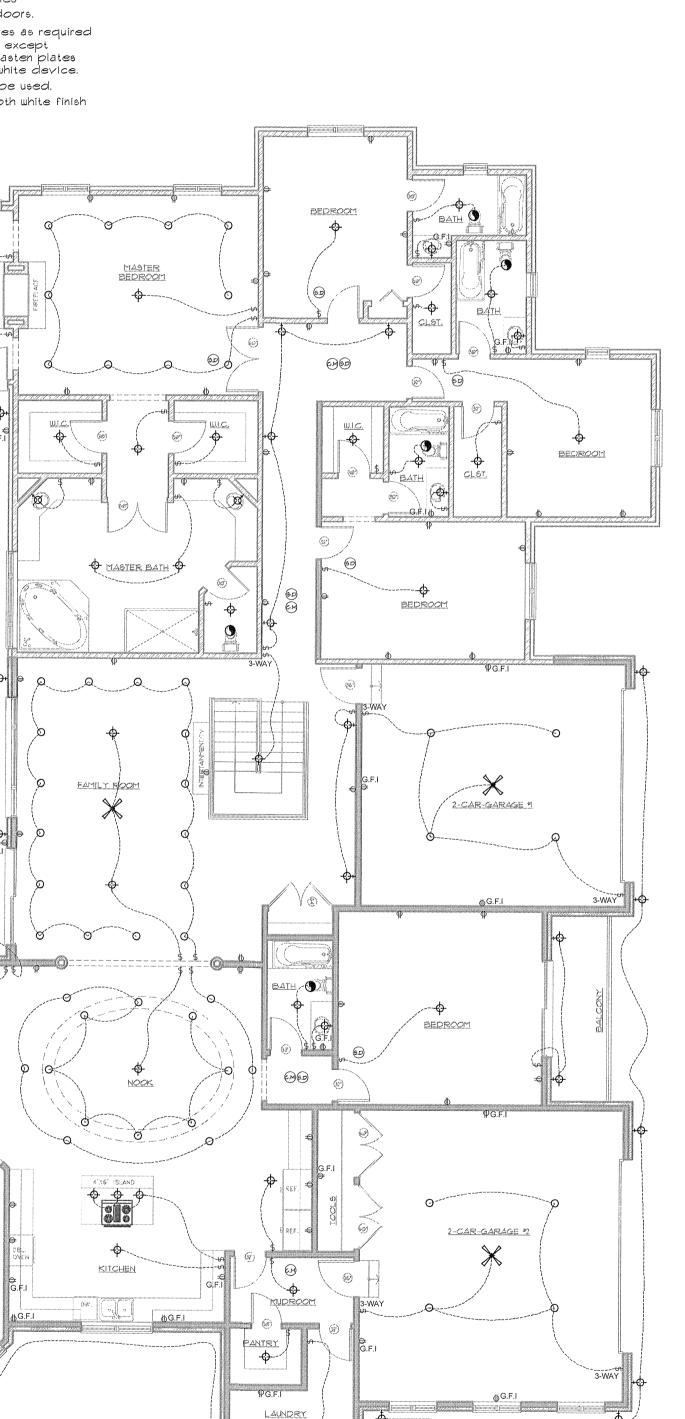

-----DATE: 03/15/202 DRAWN BY MONEER ALAHWA SCALE: AS NOTE SHEET TITLE: - ELECTRICAL PLANS SHEET #: E-1 APPROVED BY: TAHA M. KHALAFF ENGINEER No.

Cell Phone: (313) 505-7744 Email: alahwalmoneer@gmail.com

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REVISIONS:

MA ARCHMASTER

Residential & Commercial Designs